Construo Development 275 Main street Boston Ma, 02125

615 Albany St Proposal

- 1) Project timeline & revisions
- 2) Original Proposed Elevation
- 3) Existing conditions
- 4) Sedic Proposal

August 8 2023:

First BPDA prefile meeting for the project. Notes were provided on our initial proposed plans & feedback was incorporated into the initial design.

November 14 2023:

2nd prefile meeting with BPDA. Plans were well received and SPRA application process started.

April 2024

Proponent applies to participate in downtown boston office to residential conversion Pilot program. Interagency review runs smoothly & swiftly since we already have our SPRA together.

MAY 7th SEDLC Meeting Comments and Notes:

Massing:

Stair Shaft:

Siding alternatives of the egress stair tower were discussed. A vertical pattern with horizontal accents to break-up the vertical scale. A copper look was recommended if practical.

RESPONSE: A metal panel siding with a seam that offers a subtle shadow line has been proposed (Sterracore by Atlas Internation) with a vertical orientation. A subtle horizontal protrusion of the same material has been added to provide shadow lines that vertically scale down the tower to a more manageable proportion.

Windows:

The style and placement of the windows was discussed and how they fit with the proportions of the building. It was recommended that the spacing and orientation of the new windows better address the existing building and windows below.

RESPONSE: We feel that the proposed windows should maintain a dialogue with the modern expression of the 5th and 6th floor. However, the windows have been scaled down to the size of the existing windows below as well as maintaining an alignment with the pattern of the existing windows below.

Addition Set back:

Concerns were raised about the addition and setbacks. The renderings were not available at this time and the movement on the 5th and 6th story was difficult to see from the elevations. It was recommended again the proportions should match the building below better.

Response: We have revisited the setback of the 5th and 6th floor addition to address the proportions of the building below. A portion of the 5th and 6th floor is still "pulled out" to align with the brick below the corbels, but they are proportioned and centered to better address the over all scale of the building and neighboring buildings on Albany Street.

Materials:

Discussions were had on alternative materials for the shaft and 5 & 6th story.

Response: The proposed siding at the stair tower, "pull-out" accents and roof top headhouse will be Sterracore by Atlas international that addresses the commercial scale of the neighborhood. The proposed siding of the remaining 5th and 6th floors will be Versa-Seam by the same manufacturer and offers a more residential scale and addresses the horizontal articulation of the existing brick below.

June 4th Meeting:

On June 4th we presented the revised plans incorporating all notes from the May 7 meeting. The proposed plans were well received.

Revision To address Accessibility entrances:

The 2nd entrance that was being added to provide accessible entrance has been removed. At the request of MAAB, we have revised so that the main entrance has been redesigned to accommodate an accessible ramp. Now, all residents enter through the same door. A big undertaking, This is will also provide a much better solution for maintaining the historic elements of the albany st facade.

September 2024:

The proposed project was well received at BPDA & approved at this meeting.

October 2024:

The proposed project was approved by ZBA.

December 2024

Presenting the final plans before the commission today in hopes of final approval.



















WP

POUNDS

WORKING POINT

Albany Street Residences

615 Albany Street, Boston, MA 02118

CODE ANALYSIS:

1. APPLICABLE CODES **BUILDING CODE:** IBC 2015 (780 CMR) IEBC 2015 IECC 2018 IFC 2015 (527 CMR) 8TH EDITION AMENDMENTS

2. ZONING DISTRICT - IS (INSTITUTIONAL)

PROPOSED CONFORMITY CONFORMITY NO CHANGE FRONT: RIGHT: NO CHANGE LEFT: **NO CHANGE NO CHANGE** REAR: HEIGHT: 120' ~59'-1"

FAR: 4.0 LOT SIZE: 3,677 SF ALLOWED: 14,708 SF EXISTING: 19,200 SF (F.A.R. = 5.22) PROPOSED: 19,817 SF (F.A.R. = 5.38)

3. USABLE OPEN SPACE REQUIREMENTS: 200 SF PER UNIT TOTAL REQUIRED: 4,800SF PROPOSED: 725SF

GROUND LEVEL: 334SF ROOF DECK (25% OF TOTAL 1,564SF): 391SF

4. CHAPTER 2 - DEFINITIONS HIGH RISE BUILDING: A BUILDING WITH AN OCCUPIED FLOOR MORE THAN 70' ABOVE THE LOWEST LEVEL OF FIRE DEPT VEHICLE ACCESS. AND ELEVATOR HOISTWAY EXCEEDS 75 TOTAL FEET FROM LOWEST TO HIGHEST FLOOR SERVED.

THE HOISTWAY HEIGHT FROM BASEMENT TO ROOF IS 74'-10". 5. CHAPTER 3 - USE GROUP CLASSIFICATION

THE HIGHEST OCCUPIED FLOOR IS 69'-0".

6. CHAPTER 5 - BUILDING HEIGHT TABLE 504.3 - MAX HGT = 85' (TYPE 2A SPRINKLED) TABLE 504.4 - MAX STORIES = 5 (TYPE 2A SPRINKLED) TABLE 506.2 - MAX FLOOR AREA = 72,000 GSF (TYPE 2A SPRINKLED)

7. CHAPTER 6 - CONSTRUCTION CLASSIFICATION TABLE 601 - FLOOR SEPERATION - 1HR (SECTION 510.2 - 2ND FLOOR SEPARATION - 3HR) SECTION 602.2 - TYPE 1A CONSTRUCTION TO 2ND FLOOR (ALLOWED PER 510.2) SECTION 602.4 - TYPE 4A CONSTRUCTION 3RD, 4TH, 5TH & 6TH FLOORS

SECTION 510.2 EXCEPTION 1 - HORIZONTAL SEPARATION ALLOWANCE FOR 2ND FLOOR

8. CHAPTER 7 - FIRE PARTITIONS SECTION 708.3 - UNIT SEPERATION: 1 HOUR MIN SECTION 711.2.4.3 - FLOOR SEPARATION: 1 HOUR MIN (SECTION 510.2 - 2ND FLOOR SEPARATION - 3HR)

9. CHAPTER 10 - MEANS OF EGRESS: TABLE 1006.3.(1) - TWO EXITS OR EXIT ACCESS REQUIRED

SECTION 310.0 - R2


9.4 MULTIPLE DEWLLINGS THAT CONATIN 20 OR MOR UNITS A MINIMUM 5% SHALL BE GROUP 2A. 615 ALBANY STREET RESIDENCES: 29 UNITS = 1.45 GROUP 2A UNITS REQUIRED TWO GROUP 2A UNITS ARE PROPOSED. UNIT #6 AND UNIT #12 COMPLY WITH:

9.5 DWELLING UNIT INTERIORS 44.00 BATHROOMS 45.00 KITCHENS 47.00 BEDROOMS

SYMBOL LEGEND

EXISTING WALL PROPOSED WALL


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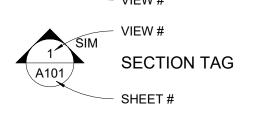


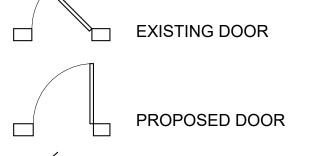EXISTING DOOR TO BE REMOVED

Room name

ROOM TAG




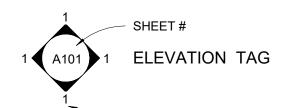

1HR RATED PARTITION (UL DESIGN U309)



EGRESS LIGHTING

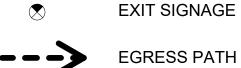

SA/CO COMBO SMOKE/CO DETECTOR -

KIDDE I12010SCO

SA/CO

COMBO SMOKE/CO DETECTOR (PHOTOELECTRIC) KIDDE KN-COPE-IC

DRAWING LIST

A000 TITLE SHEET A100 DEMO 2ND & 3RD FLOOR PLANS A101 A102 DEMO 4TH & 5TH FLOOR PLANS A103 **BASEMENT & 1ST FLOOR PLANS** A104 2ND & 3RD FLOOR PLANS 4TH & 5TH FLOOR PLANS A106 HEAD HOUSE & ROOF PLAN A107 SITE PLAN A200 **EXTERIOR ELEVATIONS** A201 **EXTERIOR ELVATIONS** A203 **EXISTING ELEVATIONS** A204 **EXISTING ELVATIONS** A202 COASTAL FLOOD RESILIENCE A210 STREET ELEVATIONS SIDING INFO A213

SHEET NAME

GENERAL NOTES:

CODES AND REGULATIONS. UNLESS OTHERWISE AGREED UPON, THE CONTRACTOR IS RESPONSIBLE FOR SECURING ALL BUILDING PERMITS AS REQUIRED TO PERFORM HIS OR HER WORK AND WILL RETAIN AND PAY FOR ALL REQUIRED INSPECTIONS FOR THE DURATION OF CONSTRUCTION.

2. CONTRACTOR SHALL VERIFY ALL EXISTING CEILINGS AND EGRESS STAIRS ARE 1HR FIRE RATED. SINGLE LAYER OF PLASTER OR 5/8" GWB EACH SIDE OF INTERIOR PARTITION (UL DESIGN# L305) SINGLE 5/8" AT CEILINGS (UL DESIGN# L512). ALL REPLACEMENT PATCHING OR REPAIRING IS THE RESPONSIBILITY OF CONTRACTOR. CONTACT ARCHITECT IF RATING IS BELIEVED TO BE INHERENT IN EXISTING ASSEMBLY.

4. CONTRACTOR RESPONSIBLE FOR ALL PREPARATION WORK REQUIRED BY MANUFACTURER'S SPECIFICATIONS.

6. CONFLICTS BETWEEN SITE CONDITIONS AND DRAWINGS SHALL BE BROUGHT TO THE IMMEDIATE ATTENTION OF THE ARCHITECT OR THE APPROPRIATE CONSULTING ENGINEERS.

CONSULTING ENGINEER.

8. CONTRACTOR TO NOTIFY ARCHITECT, AFTER LAYOUT AND PRIOR TO FRAMING, OF ANY DISCREPANCY, OMISSION, OR UNANTICIPATED FIELD CONDITIONS ALTER THE DESIGN INTENT.

11. DAMAGED TO EXISTING OR NEW CONSTRUCTION CAUSED BY THE CONTRACTOR, HIS OR HER SUB-CONTRACTORS OR CREW IS THE RESPONSIBILITY

SHEET# DEMO BASEMENT & 1ST FLOOR PLANS

1. WORK SHALL COMPLY WITH FEDERAL, STATE AND LOCAL BUILDING

3. CONTRACTOR SHALL ENGAGE A LICENSED ELECTRICIAN FOR ALL ELECTRICAL WORK AND IN COMPLIANCE WITH NFPA 70.

5. CONTRACTOR SHALL PROVIDE PRODUCT SUBMITTAL FOR SMOKE ALARM FIXTURES FOR APPORVAL

7. CONFIRM DIMENSIONS WITH THE ARCHITECT OR APPROPRIATE

9. CONTRACTOR TO NOTIFY ARCHITECT, AFTER LAYOUT AND PRIOR TO FRAMING, IF DIMENSIONS INDICATED WITH "+/-" VARIES MORE THAN 3" FROM ACTUAL FIELD MEASURMENTS

10. CONTRACTOR RESPONSIBLE FOR ALL PREPARATION WORK REQUIRED BY MANUFACTURER'S SPECIFICATIONS.

OF THE CONTRACTOR.

REVISIONS:

1\ CODE/UNIT

ARCHITECT

suite #30

PROJECT:

Albany Street

Residences

615 Albany St

CLIENT:

275 Main St

Charlestown, MA

PROJECT TEAM:

Boston, MA 02118

River Front Realty

517 boston post rd

sudbury, ma 01776

p: 508.500.4730 www.s47a.com

DRAWING TITLE:


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STAMP




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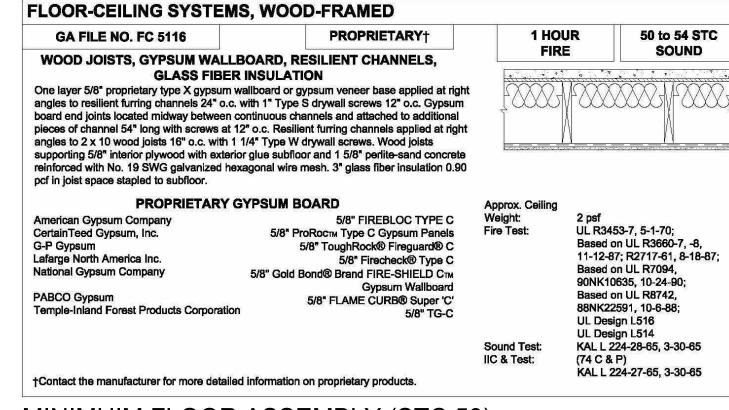


METAL STUD (0HR)

PARTITION TYPES

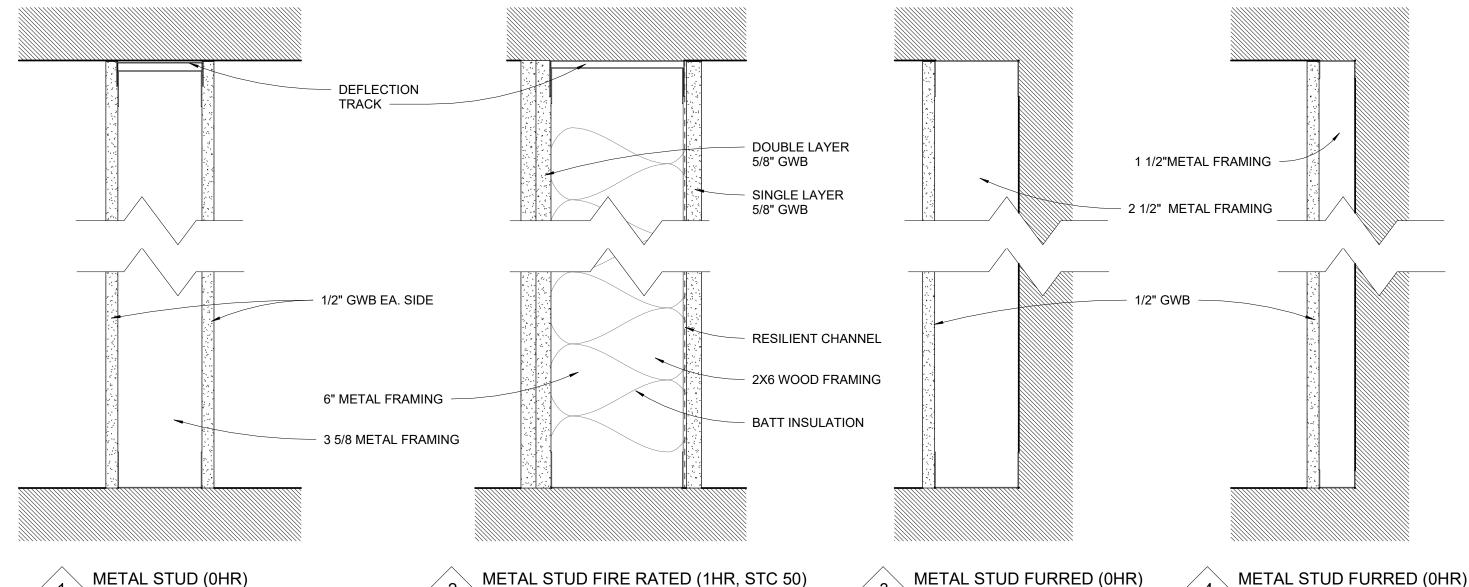

UNIT #16

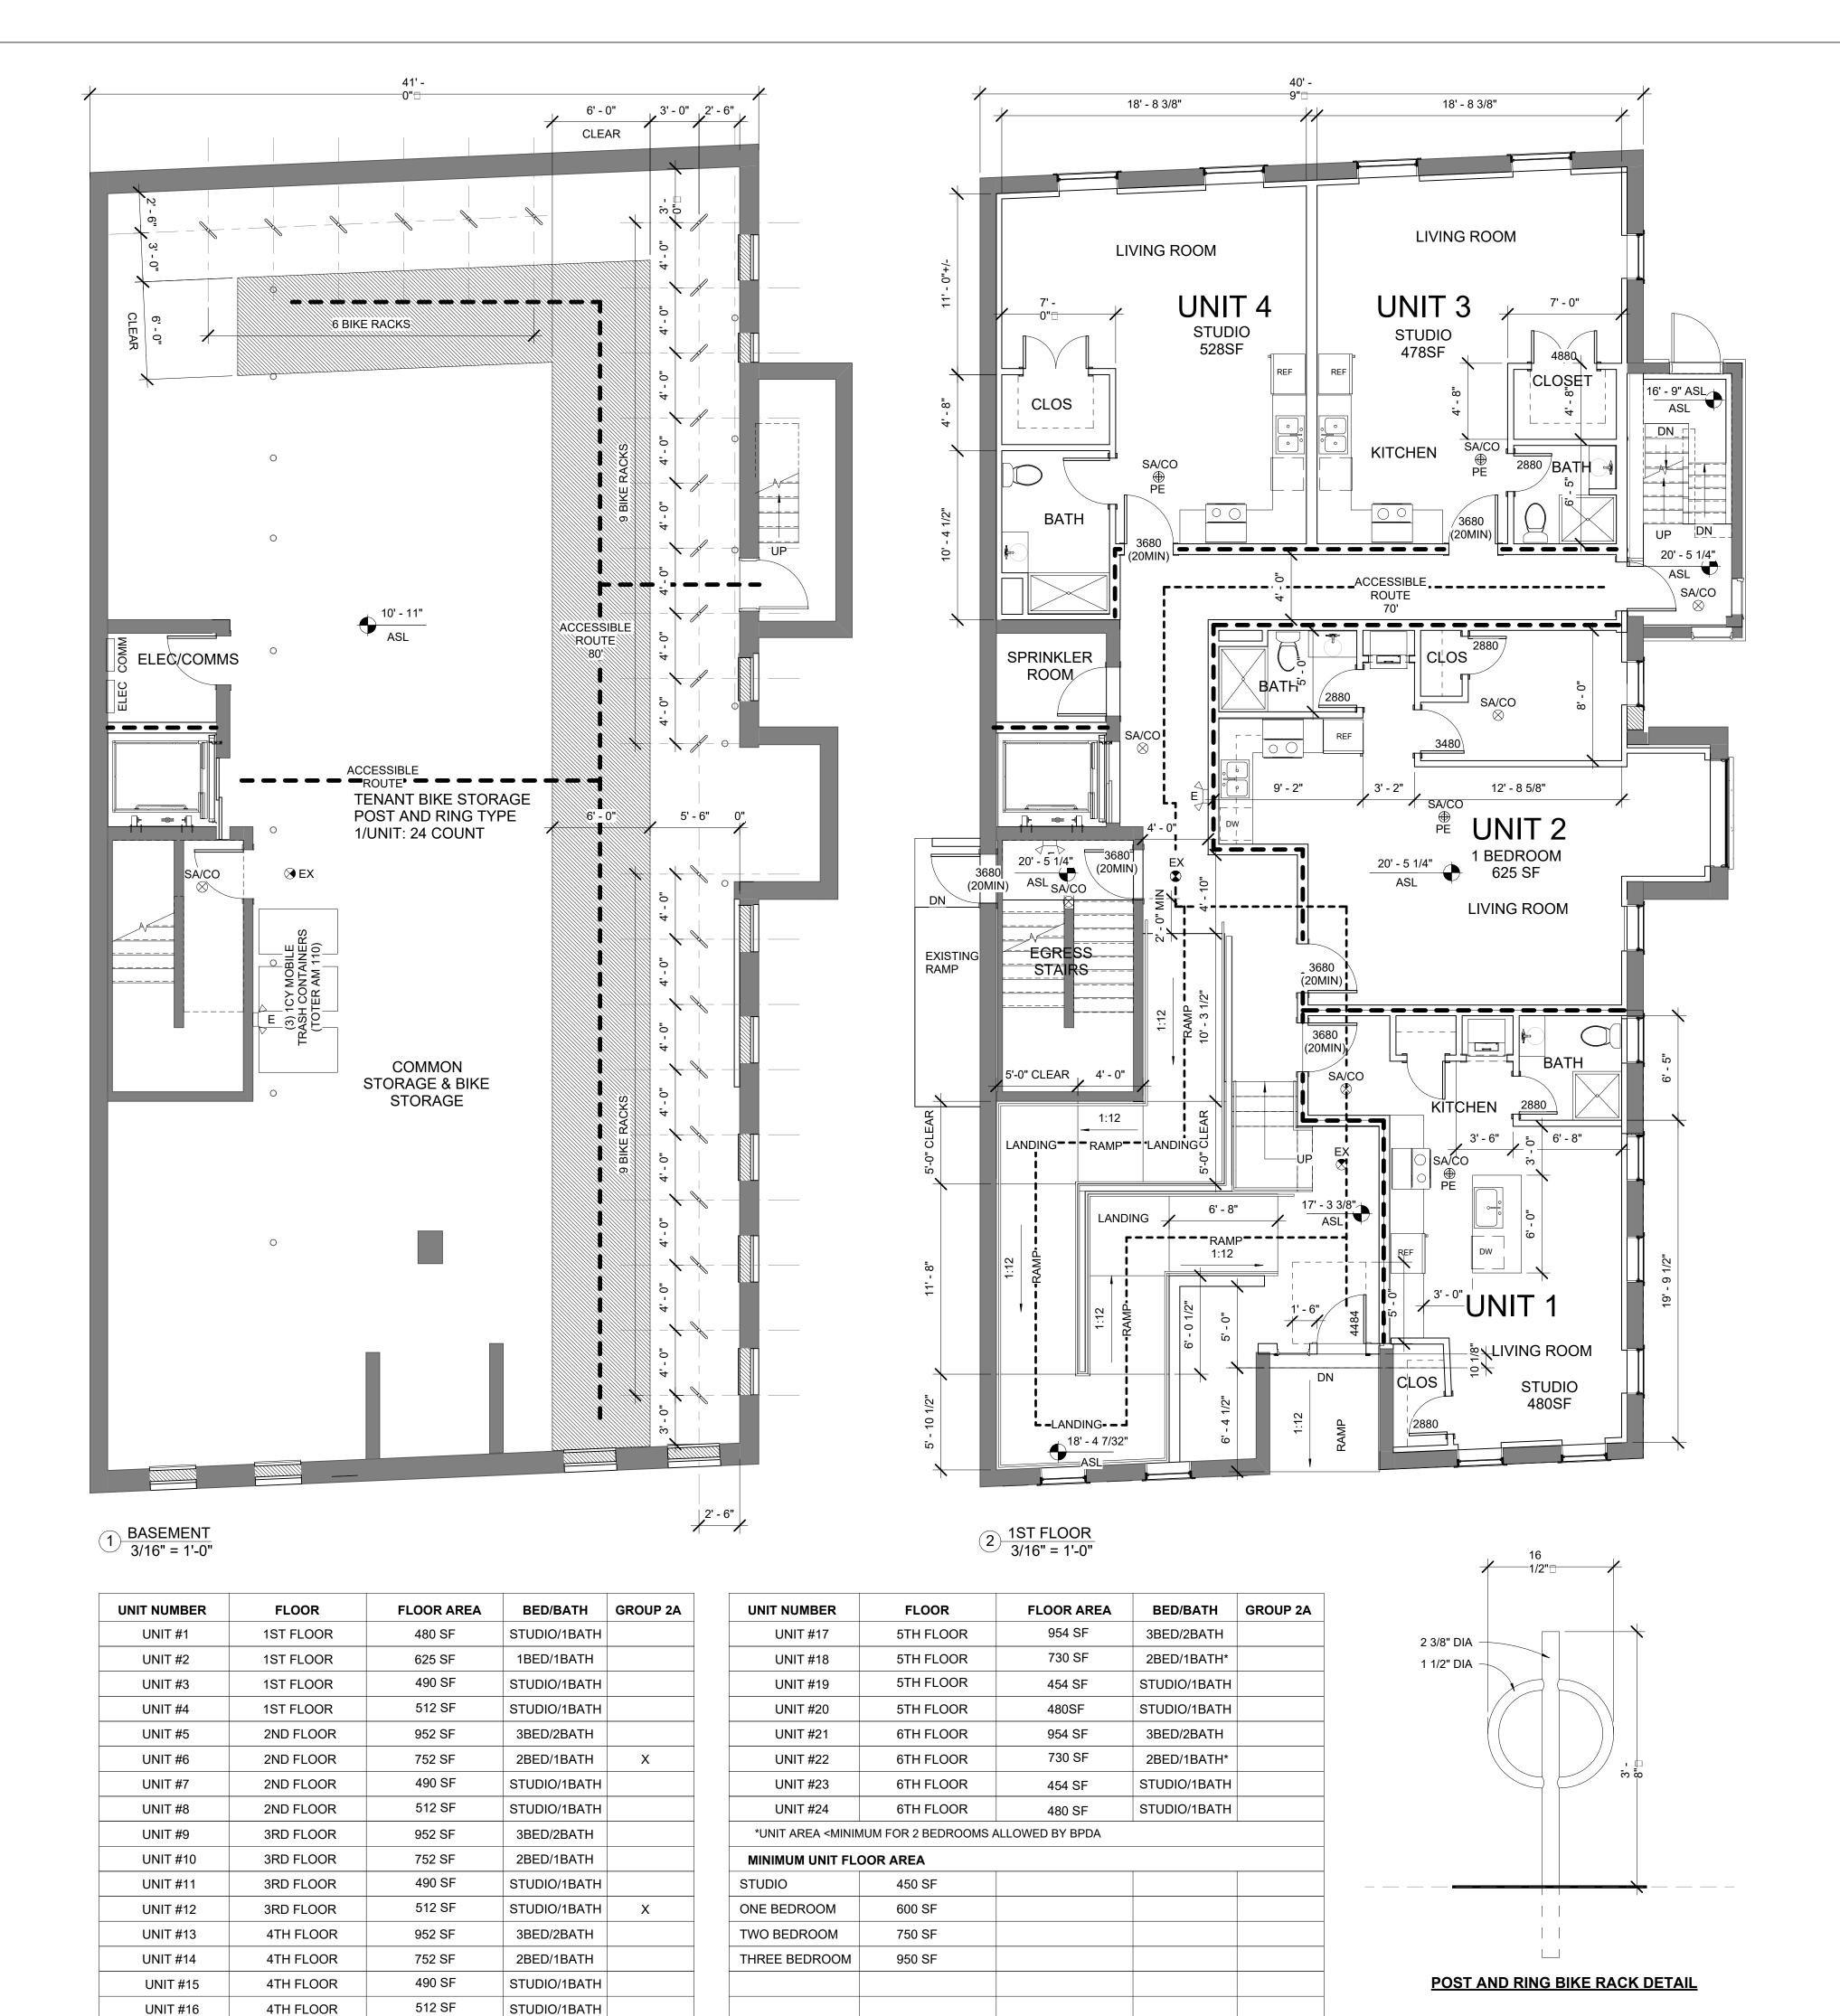

MINIMUIM FLOOR ASSEMBLY (STC 50)

DESIGN NO.	UL U419		
FIRE RATING: STC RATING: SOUND TEST: SYSTEM THICKNESS: LOCATION: FRAMING TYPE:	1 HOUR 50 USG-160727 5-1/2" [140 MM] INTERIOR STEEL STUD (NONLOAD-B	BEARING)	
S I	24" [610 mm]	24" [610 mm]	
5 1/2" [140 mm]			

ASSEMBLY REQUIREMENTS:

GYPSUM PANELS: TWO LAYERS 5/8" [15.9 MM] SHEETROCK® ECOSMART GYPSUM PANEL (UL TYPE ULIX™) STEEL STUDS: 3-5/8" [92 MM] STEEL STUDS, EQ20 (0.018"), 24" [610 MM] O.C. INSULATION: 3-1/2" [89 MM] FIBERGLASS INSULATION ONE LAYER 5/8" [15.9 MM] SHEETROCK® ECOSMART GYPSUM PANEL (UL TYPE ULIX™) **GYPSUM PANELS:**

SYMBOL LEGEND


- REFER TO APPLICABLE CODES REQUIREMENTS TO ENSURE COMPLIANCE PRIOR TO CONSTRUCTION.
- FOR THE MOST UP-TO-DATE DETAILS, INCLUDING CONSTRUCTION VARIATIONS, REFER TO THE PUBLISHED DESIGN. WHERE DESIGN NO. INDICATES "PER", THE FIRE RATING IS BASED ON LABORATORY TEST DATA OF THE REFERENCED

FIRE-RATINGS ARE MAINTAINED WITH ONE OR MORE OF THE FOLLOWING MODIFICATIONS: INCREASE STUD DEPTH,

- SIMILARLY CONSTRUCTED ASSEMBLIES. STUD SIZES AND INSULATION THICKNESS ARE MINIMUM UNLESS OTHERWISE STATED IN THE PUBLISHED ASSEMBLY.
- STUD AND FASTENER SPACINGS ARE MAXIMUM UNLESS OTHERWISE STATED IN THE PUBLISHED ASSEMBLY.
- PANEL ORIENTATION SHALL BE AS SPECIFIED IN THE PUBLISHED DESIGN. FIRE-RATINGS ARE FROM BOTH SIDES UNLESS OTHERWISE STATED.
- INCREASE STUD MATERIAL THICKNESS, DECREASE STUD SPACING, DECREASE FASTENER SPACING, INCREASE INSULATION THICKNESS UP TO CAVITY DEPTH.
- WHERE ACOUSTICAL PERFORMANCE IS PROVIDED IN AN ESTIMATED RANGE, THE VALUES ARE BASED ON
- LABORATORY TEST DATA OF SIMILARLY CONSTRUCTED ASSEMBLIES.
- SOUND-RATINGS ARE MAINTAINED WITH ONE OR MORE OF THE FOLLOWING MODIFICATIONS: INCREASE STUD DEPTH, DECREASE STUD MATERIAL THICKNESS, INCREASE STUD SPACING, INCREASE FASTENER SPACING, INCREASE INSULATION THICKNESS UP TO CAVITY DEPTH. MODIFICATIONS MUST NOT EXCEED LIMITATIONS OF FIRE RATING.

ACCEPTABLE PARTY-WALL ASSEMBLY (MIN 1HR STC50)

SEE A202 FOR COASTAL FLOOD RESILIENCE DIAGRAMS

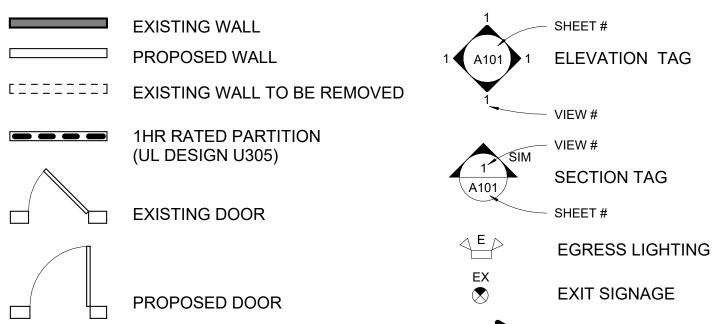


EXISTING DOOR TO BE REMOVED

EGRESS PATH

COMBO SMOKE/CO DETECTOR -KIDDE I12010SCO

COMBO SMOKE/CO DETECTOR (PHOTOELECTRIC) KIDDE KN-COPE-IC

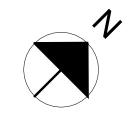

ARCHITECT

517 boston post rd suite #30 sudbury, ma 01776 p: 508.500.4730 www.s47a.com

PROJECT: **Albany Street** Residences

615 Albany St

Boston, MA 02118

CLIENT:

River Front Realty

275 Main St

Charlestown, MA


PROJECT TEAM:

REVISIONS:

DRAWING TITLE:


BASEMENT & 1ST FLOOR **PLANS**


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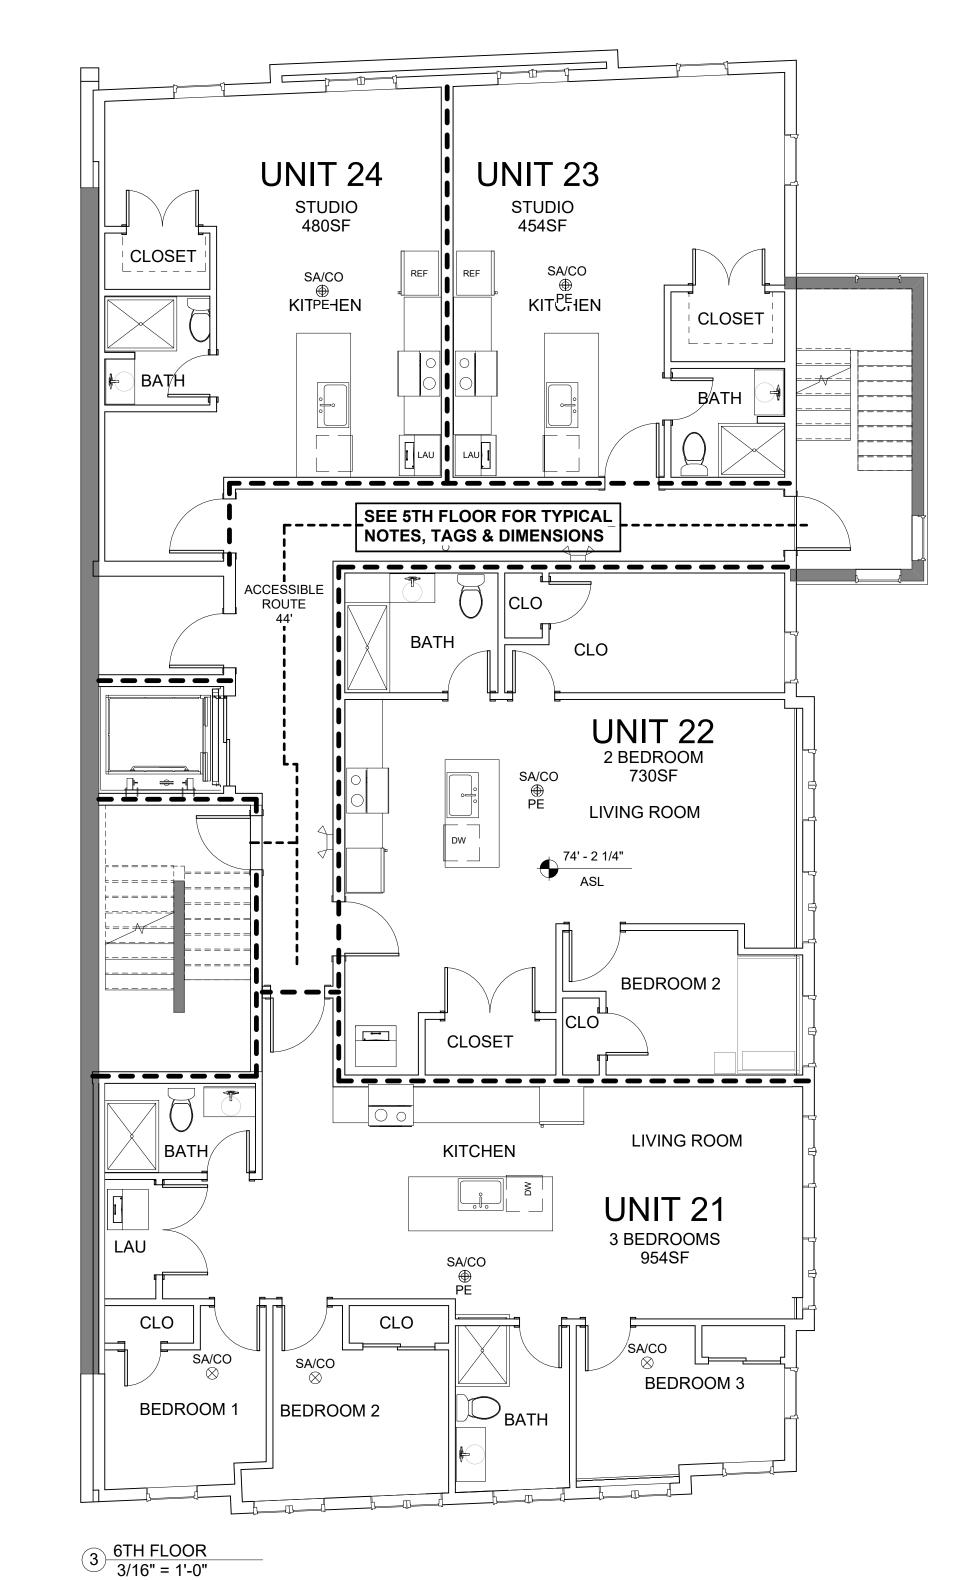
18' - 10

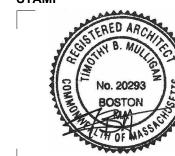18' - 1


1 4TH FLOOR 3/16" = 1'-0"

UNIT NUMBER	FLOOR	FLOOR AREA	BED/BATH	GROUP 2A
UNIT #1	1ST FLOOR	480 SF	STUDIO/1BATH	
UNIT #2	1ST FLOOR	625 SF	1BED/1BATH	
UNIT #3	1ST FLOOR	490 SF	STUDIO/1BATH	
UNIT #4	1ST FLOOR	512 SF	STUDIO/1BATH	
UNIT #5	2ND FLOOR	952 SF	3BED/2BATH	
UNIT #6	2ND FLOOR	752 SF	2BED/1BATH	Х
UNIT #7	2ND FLOOR	490 SF	STUDIO/1BATH	
UNIT #8	2ND FLOOR	512 SF	STUDIO/1BATH	
UNIT #9	3RD FLOOR	952 SF	3BED/2BATH	
UNIT #10	3RD FLOOR	752 SF	2BED/1BATH	
UNIT #11	3RD FLOOR	490 SF	STUDIO/1BATH	
UNIT #12	3RD FLOOR	512 SF	STUDIO/1BATH	Х
UNIT #13	4TH FLOOR	952 SF	3BED/2BATH	
UNIT #14	4TH FLOOR	752 SF	2BED/1BATH	
UNIT #15	4TH FLOOR	490 SF	STUDIO/1BATH	
UNIT #16	4TH FLOOR	512 SF	STUDIO/1BATH	

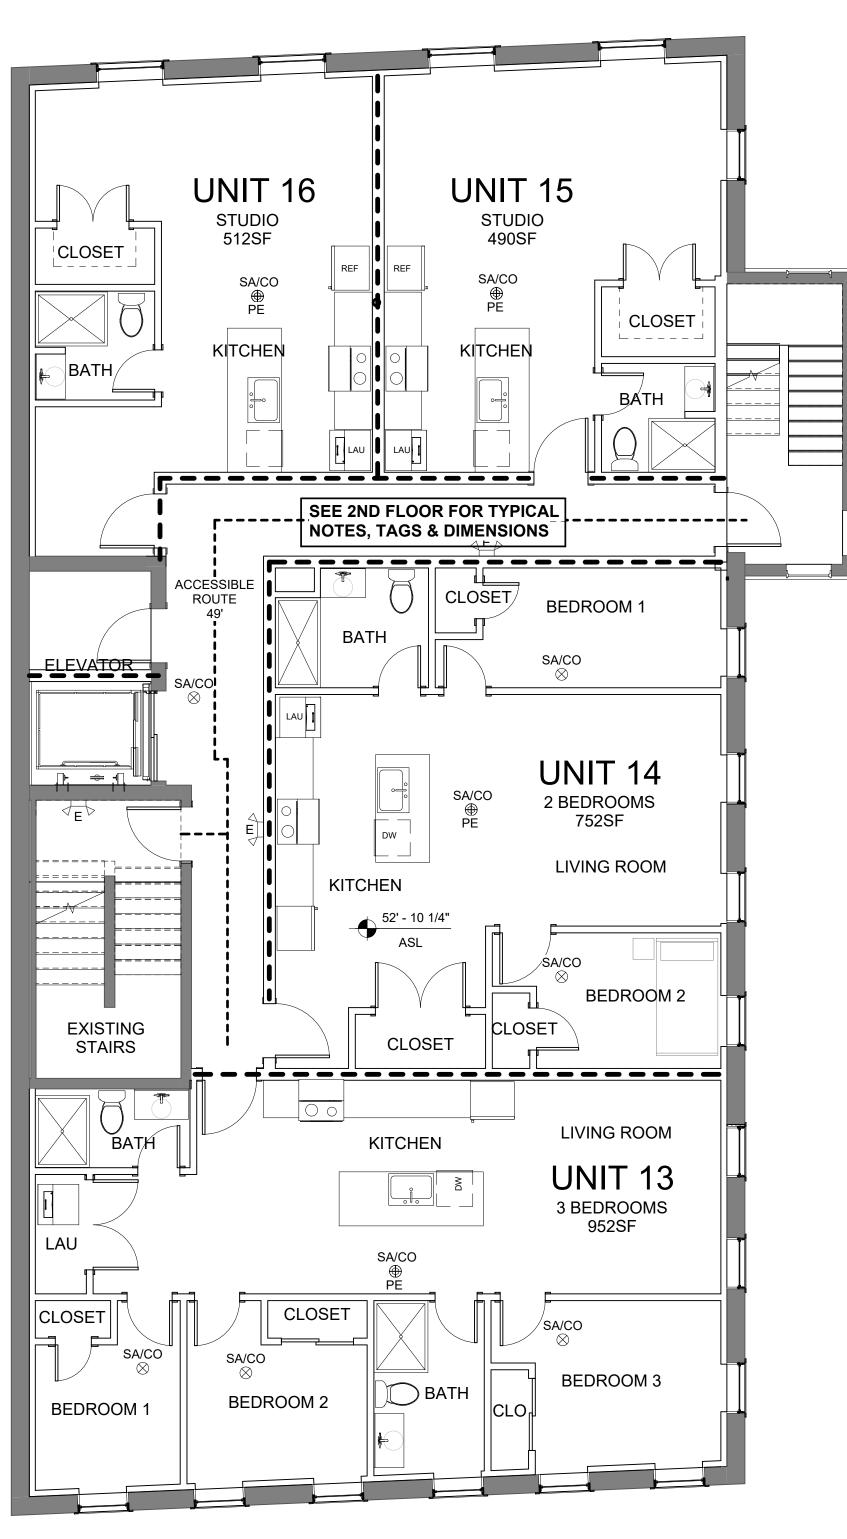1/2"□						
	UNIT NUMBER	FLOOR	FLOOR AREA	BED/BATH	GROUP 2A	
	UNIT #17	5TH FLOOR	954 SF	3BED/2BATH		
	UNIT #18	5TH FLOOR	730 SF	2BED/1BATH*		
	UNIT #19	5TH FLOOR	454 SF	STUDIO/1BATH		
	UNIT #20	5TH FLOOR	480SF	STUDIO/1BATH		
1	UNIT #21	6TH FLOOR	954 SF	3BED/2BATH		
	UNIT #22	6TH FLOOR	730 SF	2BED/1BATH*		
	UNIT #23	6TH FLOOR	454 SF	STUDIO/1BATH		
	UNIT #24	6TH FLOOR	480 SF	STUDIO/1BATH		
	*UNIT AREA <minim< td=""><td>IUM FOR 2 BEDROOMS A</td><td>ALLOWED BY BPDA</td><td></td><td></td></minim<>	IUM FOR 2 BEDROOMS A	ALLOWED BY BPDA			
	MINIMUM UNIT FLO	OOR AREA				
	STUDIO	450 SF				
	ONE BEDROOM	600 SF				
	TWO BEDROOM	750 SF				
	THREE BEDROOM	950 SF				

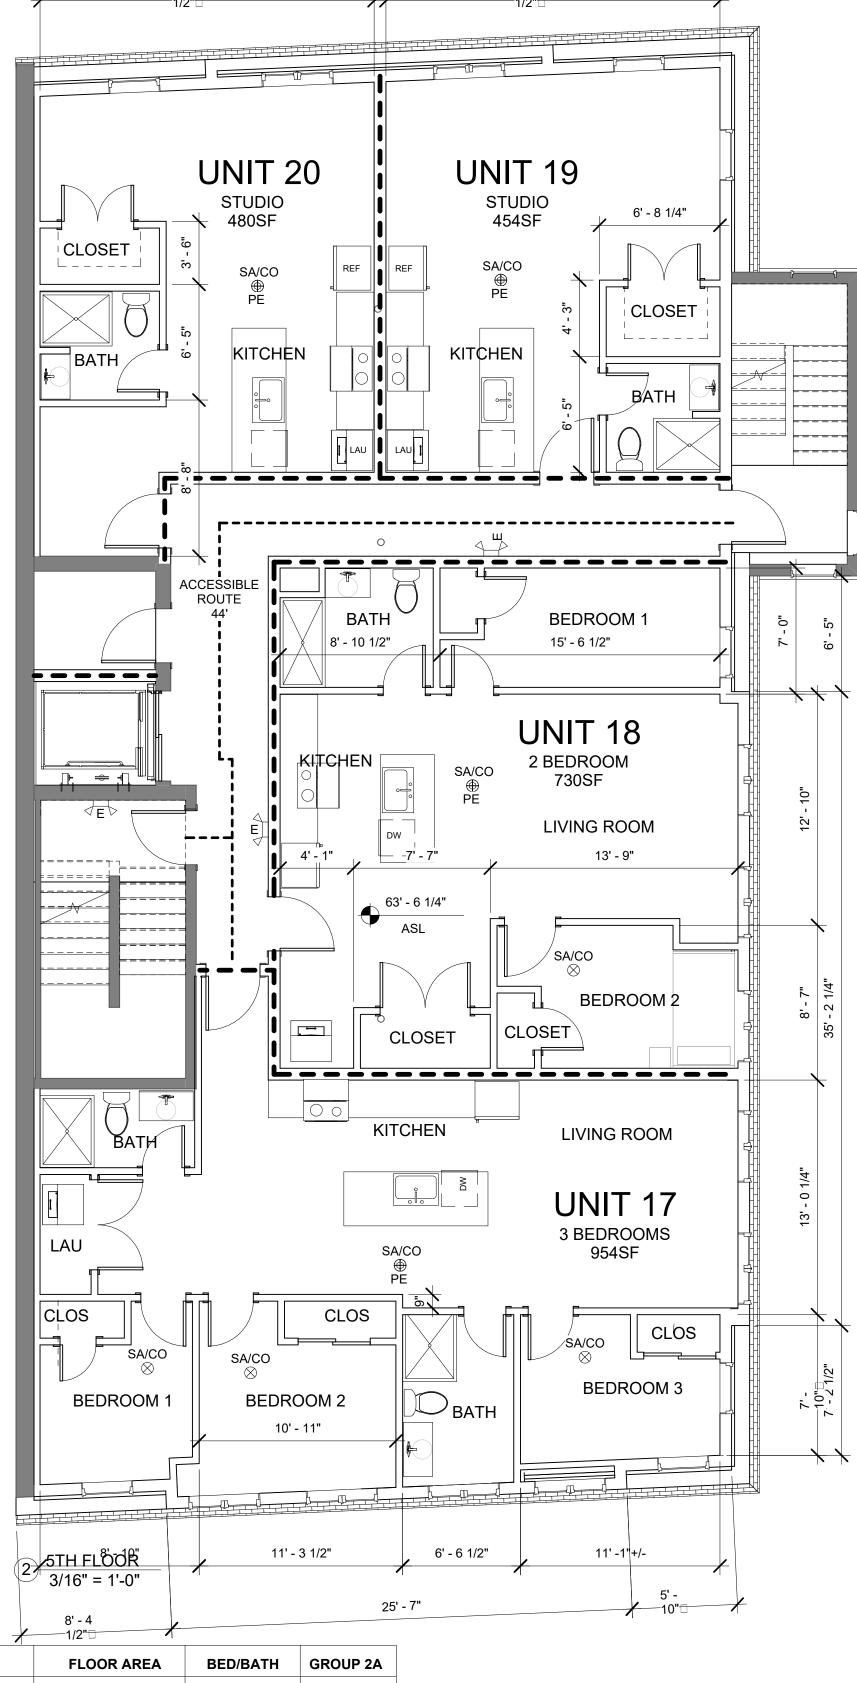

SYMBOL LEGEND

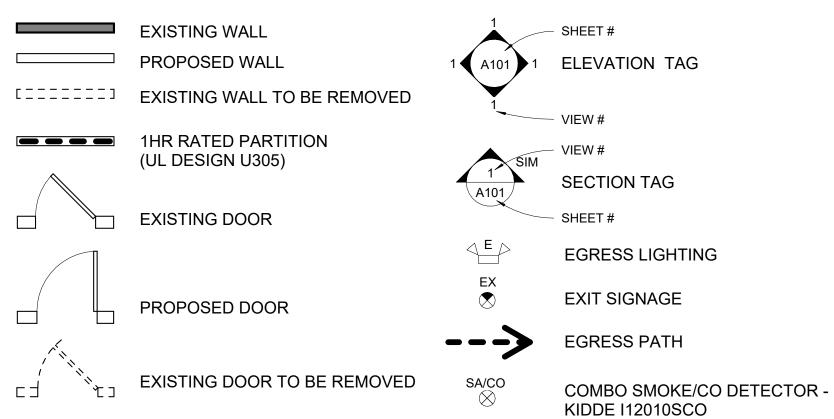

COMBO SMOKE/CO DETECTOR

(PHOTOELECTRIC) KIDDE KN-COPE-IC

ARCHITECT 517 boston post rd suite #30

sudbury, ma 01776 p: 508.500.4730 www.s47a.com

PROJECT: **Albany Street** Residences 615 Albany St Boston, MA 02118

CLIENT: **River Front Realty**

275 Main St Charlestown, MA


PROJECT TEAM:

REVISIONS:

DRAWING TITLE:


4TH & 5TH **FLOOR PLANS**


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PERMITTING DOCUMENT PHASE As indicated SCALE

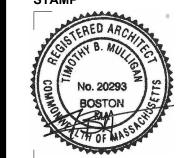DRAWING NUMBER:



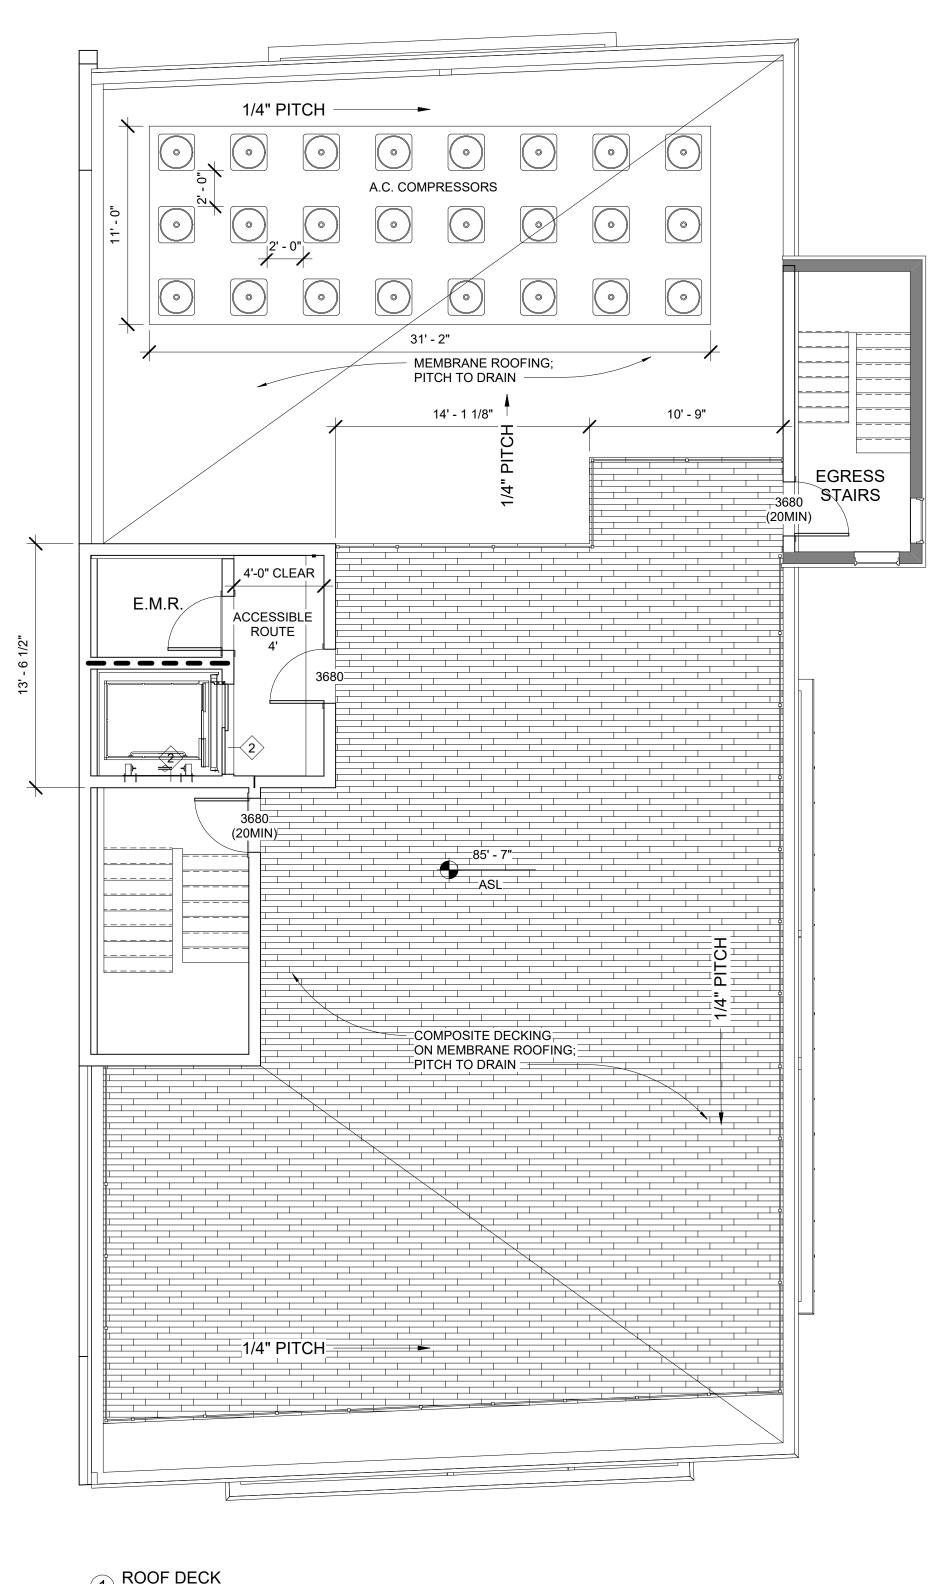



1 ROOF DECK 3/16" = 1'-0"

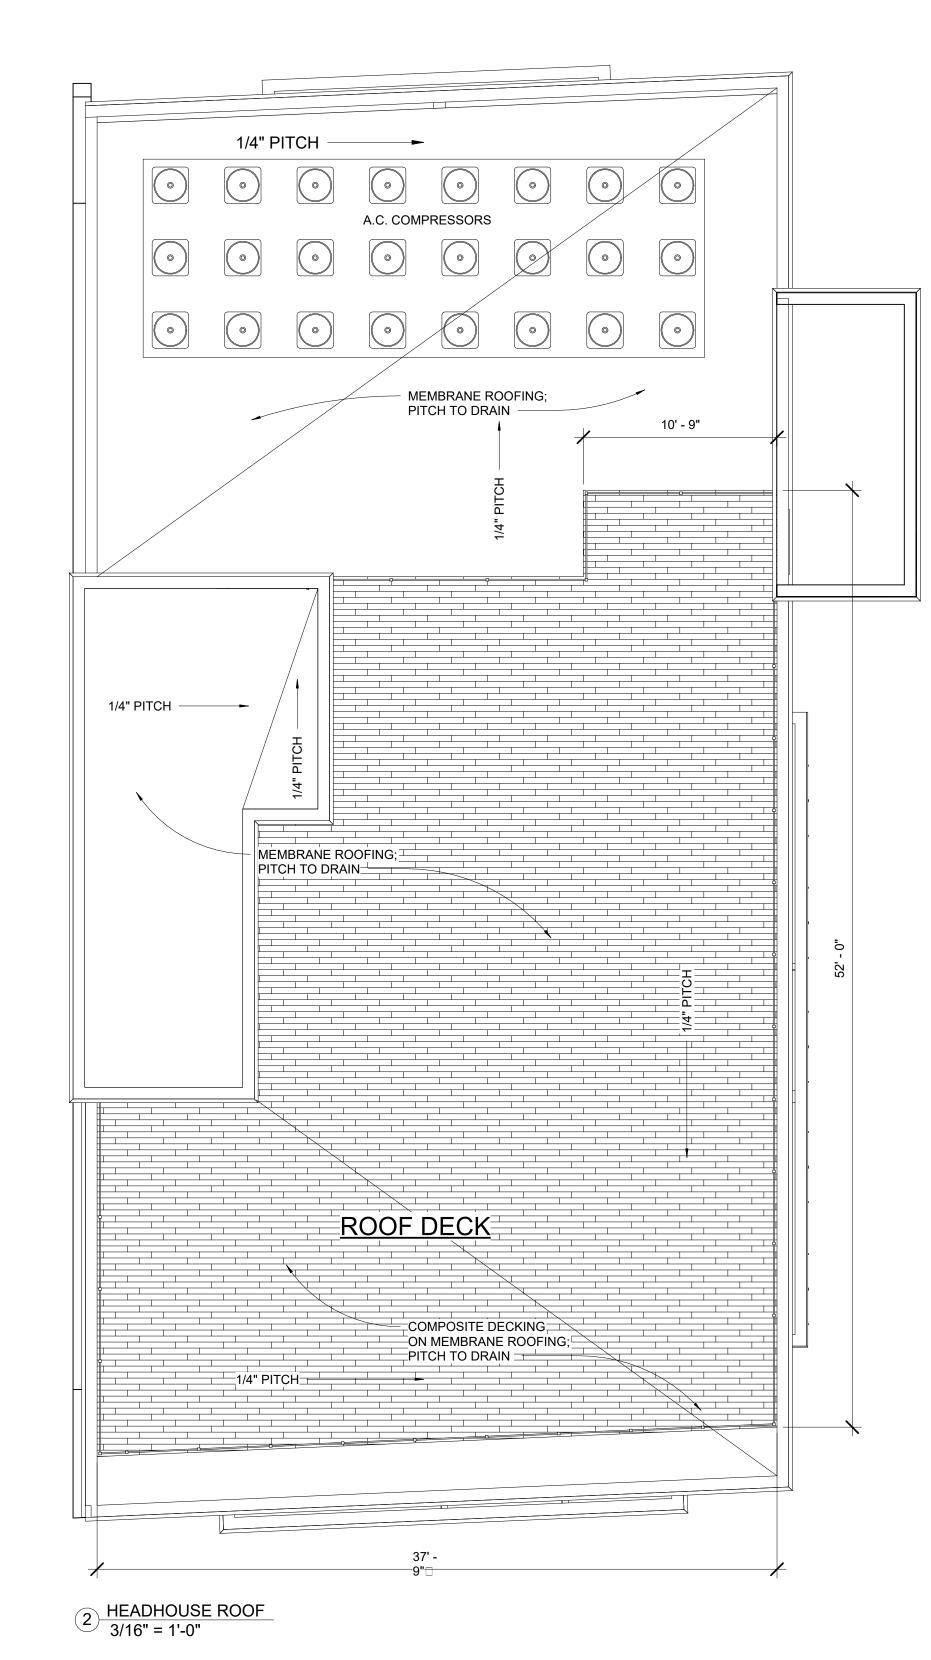
UNIT NUMBER	FLOOR	FLOOR AREA	BED/BATH	GROUP 2A
UNIT #1	1ST FLOOR	480 SF	STUDIO/1BATH	
UNIT #2	1ST FLOOR	625 SF	1BED/1BATH	
UNIT #3	1ST FLOOR	490 SF	STUDIO/1BATH	
UNIT #4	1ST FLOOR	512 SF	STUDIO/1BATH	
UNIT #5	2ND FLOOR	952 SF	3BED/2BATH	
UNIT #6	2ND FLOOR	752 SF	2BED/1BATH	Х
UNIT #7	2ND FLOOR	490 SF	STUDIO/1BATH	
UNIT #8	2ND FLOOR	512 SF	STUDIO/1BATH	
UNIT #9	3RD FLOOR	952 SF	3BED/2BATH	
UNIT #10	3RD FLOOR	752 SF	2BED/1BATH	
UNIT #11	3RD FLOOR	490 SF	STUDIO/1BATH	
UNIT #12	3RD FLOOR	512 SF	STUDIO/1BATH	Х
UNIT #13	4TH FLOOR	952 SF	3BED/2BATH	
UNIT #14	4TH FLOOR	752 SF	2BED/1BATH	
UNIT #15	4TH FLOOR	490 SF	STUDIO/1BATH	
UNIT #16	4TH FLOOR	512 SF	STUDIO/1BATH	

UNIT NUMBER	FLOOR	FLOOR AREA	BED/BATH	GROUP 2A
UNIT #17	5TH FLOOR	954 SF	3BED/2BATH	
UNIT #18	5TH FLOOR	730 SF	2BED/1BATH*	
UNIT #19	5TH FLOOR	454 SF	STUDIO/1BATH	
UNIT #20	5TH FLOOR	480SF	STUDIO/1BATH	
UNIT #21	6TH FLOOR	954 SF	3BED/2BATH	
UNIT #22	6TH FLOOR	730 SF	2BED/1BATH*	
UNIT #23	6TH FLOOR	454 SF	STUDIO/1BATH	
UNIT #24	6TH FLOOR	480 SF	STUDIO/1BATH	
*UNIT AREA <minin< td=""><td>IUM FOR 2 BEDROOMS A</td><td>ALLOWED BY BPDA</td><td></td><td></td></minin<>	IUM FOR 2 BEDROOMS A	ALLOWED BY BPDA		
MINIMUM UNIT FLO	OOR AREA			
STUDIO	450 SF			
ONE BEDROOM	600 SF			
TWO BEDROOM	750 SF			
THREE BEDROOM	950 SF			

SYMBOL LEGEND

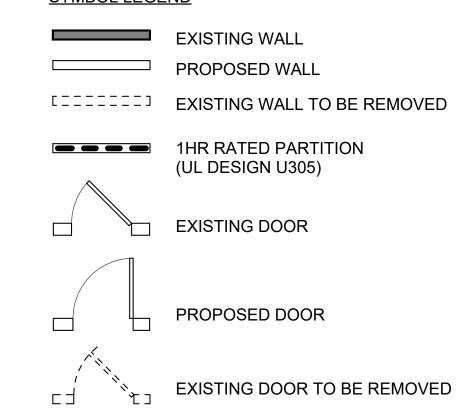

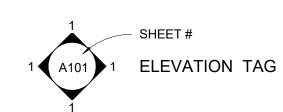

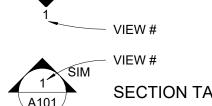








EGRESS PATH



COMBO SMOKE/CO DETECTOR -KIDDE I12010SCO



COMBO SMOKE/CO DETECTOR (PHOTOELECTRIC) KIDDE KN-COPE-IC

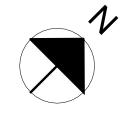

ARCHITECT 517 boston post rd

suite #30

sudbury, ma 01776 p: 508.500.4730 www.s47a.com PROJECT: Albany Street Residences 615 Albany St Boston, MA 02118 CLIENT: River Front Realty 275 Main St Charlestown, MA PROJECT TEAM:

REVISIONS:

DRAWING TITLE: **HEAD HOUSE** & ROOF PLAN

STAMP

PERMITTING DOCUMENT PHASE

As indicated SCALE

DRAWING NUMBER:

VARIES 7' - 0" MIN EXPANSION ABUTTING PROPERTY JOINT 4' - 0" MIN 3' - 0" 13' - 0" +/-EXISTING CONDITION EXPANSION JOINT EASMENT 7' - 5"+/-EXISTING CONDITION CONCRETE WALKWAY 4' - 10 1/2" 5' X10' GARBAGE PICK-UP LOCATION. GARBAGE COLLECTED ON BASEMENT LEVEL AND WHEELED UP TO CURB ON TRASH DAY #=====**#** _____ ====== 8' - 6" +/-====== EXISTING CONDITION ====== --------13' - 9" +/-EXISTING CONDITION PROPOSED RELOCATED CROSSWALK CONCRETE WALKWAY RELOCATED | RAMP | PROPOSED RELOCATED CROSSWALK VISITOR BIKE RACK POST & RING TYPE (SEE A104)

S47 a

517 boston post rd suite #30 sudbury, ma 01776 p: 508.500.4730 www.s47a.com

PROJECT:
Albany Street
Residences

615 Albany St Boston, MA 02118

CLIENT:
River Front Realty

Taron Front Roal

275 Main St Charlestown, MA

PROJECT TEAM:

REVISIONS:

DRAWING TITLE:

SITE PLAN

STAMP

June 5, 2024
DATE OF ISSUE

PERMITTING
DOCUMENT PHASE

3/16" = 1'-0"
SCALE

PROJECT#

DRAWING NUMBER:

A107

10004 40:00:44 DM






S47 a

studio47 architects,
517 boston post rd
suite #30
sudbury, ma 01776
p: 508.500.4730
www.s47a.com



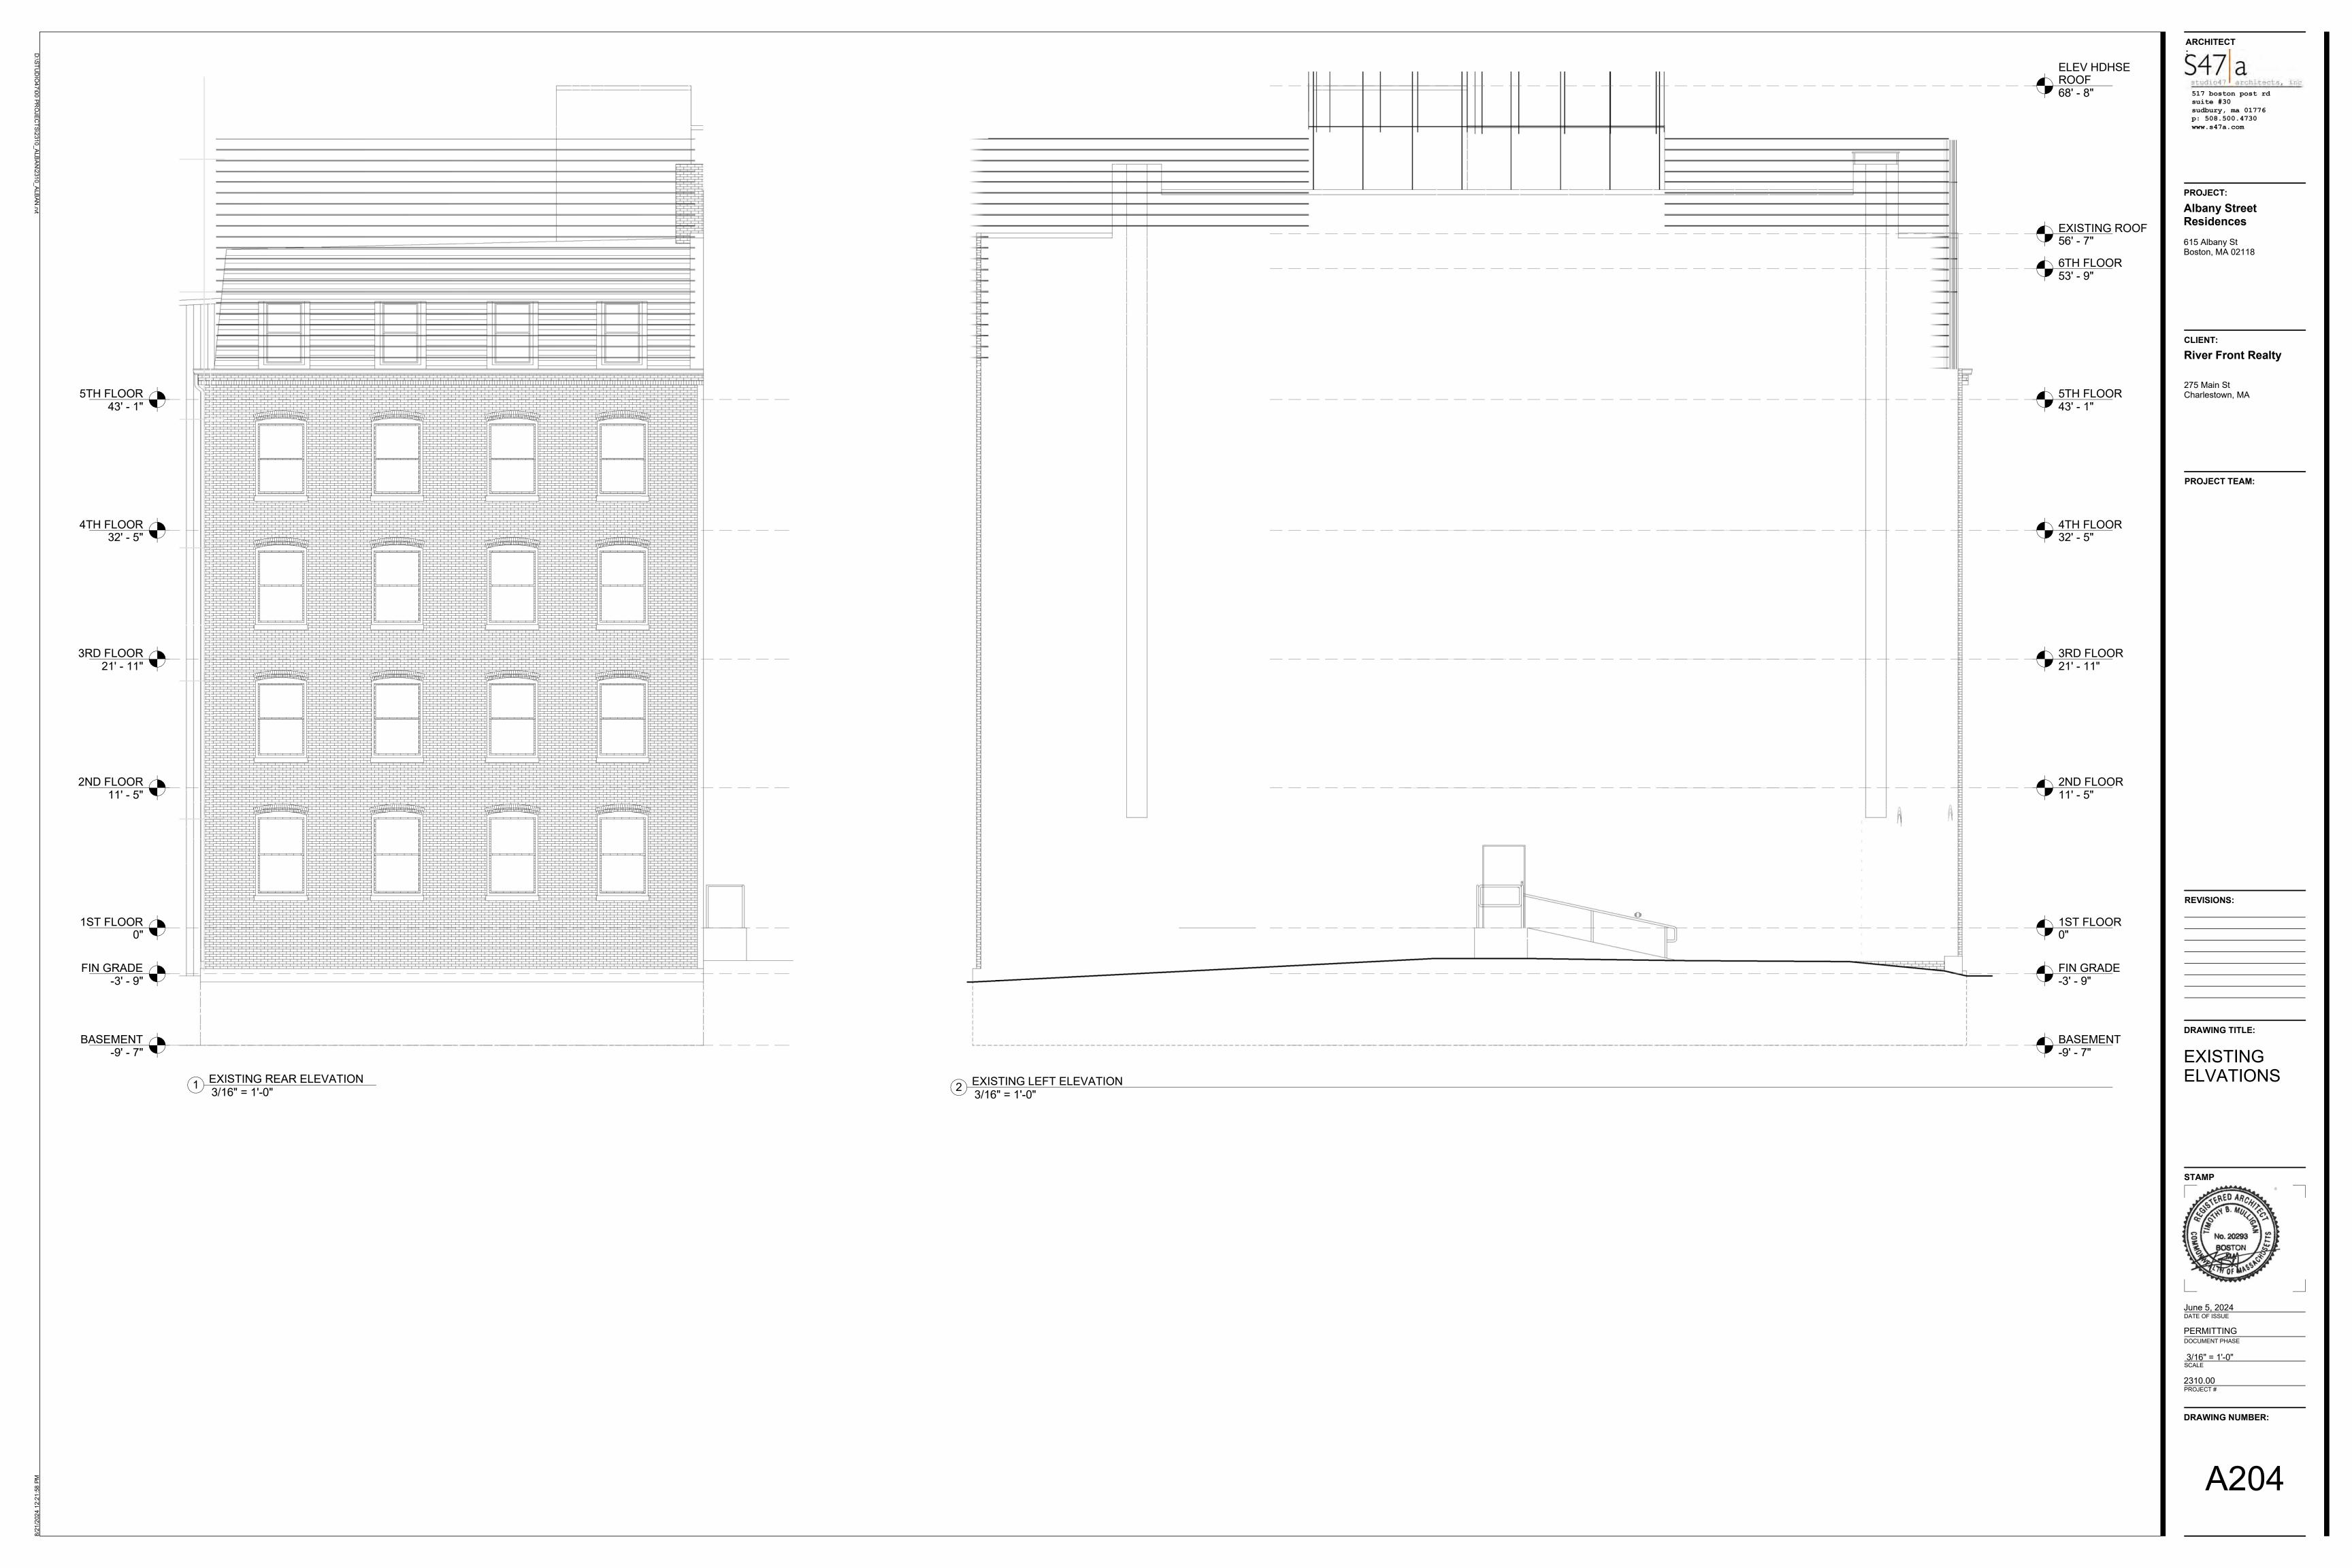



SIDING - TYPE 1



STERRACORE

SterraCore™ metal composite material panels provide durable, eye-catching fascias, soffits, canopies, and decorative towers for retail, schools, hospitals and high profile commercial projects. With over 40 stock colors, you can successfully achieve a desired look that will have long lasting impact. Panels are non-absorbent and water insensitive; consequently, they carry a limited warranty for rot, swell, corrode, or delamination. SterraCore™ panels provide highly decorative, easy to maintain, and very durable surface finishes for exterior or interior wall conditions. The overall Clip & Seal installation system produces an exceptionally flat appearance. Curving capabilities are also possible with specifically configured SterraCore panels that require no prefabrication, offsite forming or engineering.

SPECIFICATIONS:

SKU:

MAU999

Material:

.032 aluminum exterior skin

Panel Size:

48" x 96", 120", 144" (Custom sizes available)

Texture:

Smooth or Embossed

Finish:

Kynar 500® PVDF or Hylar

Anodized:

Clear Satin Anodized or Dark Bronze Anodized


Accessories:


A complete line of trims available in matching colors, gauge and finish or as specified.

Fasteners:


Concealed fasteners



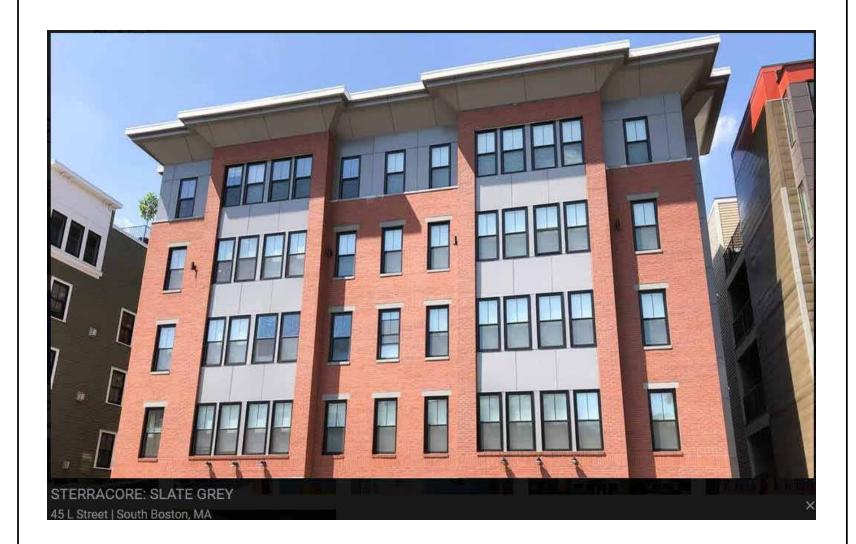

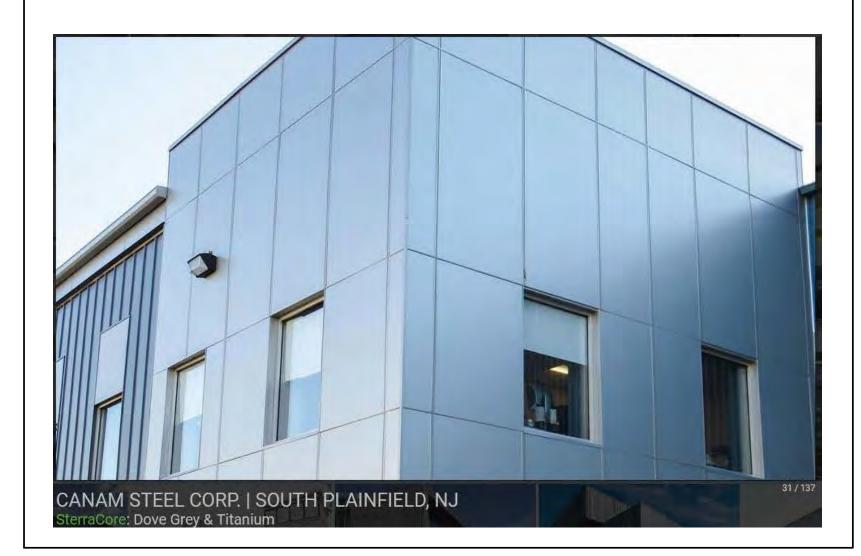

SIDING - TYPE 2

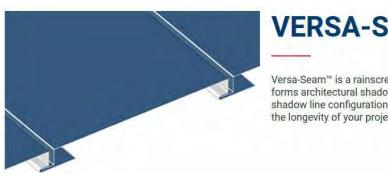

VERSA-SEAM

Versa-Seam™ is a rainscreen style system that requires a waterproof building envelope behind it. The panel forms architectural shadow lines in its horizontal installation and is available with three optional reveal or shadow line configurations and optional end folds. Pair <u>accessories</u> & fasteners with Versa-Seam™ to increase the longevity of your project.

- 1/4 in (6 mm) Reveal

- 8 in [203 mm], 10 in [254 mm], 12 in [305 mm]

Panel with Optional End Fold

VERSA-SEAM™

SKU: VSS080, VSS100, VSS120

MATERIAL .032, .040 aluminum


16, 20 oz. copper*^ .8, 1.0 mm zinc*^ .0197 classic & tin matte stainless steel*^ ^Inquire for available widths


PANEL SPECS Coverage: 8", 10", 12" | Custom widths available* Minimum Length: 3'-0" Maximum Length: 20'-0"

AVAILABLE Louvered Optional End Folds

Depth: 1"


Smooth, Stucco Embossed, or Wood Grain Embossed (.032 aluminum & .040 aluminum only) www.atas.com/versaseam

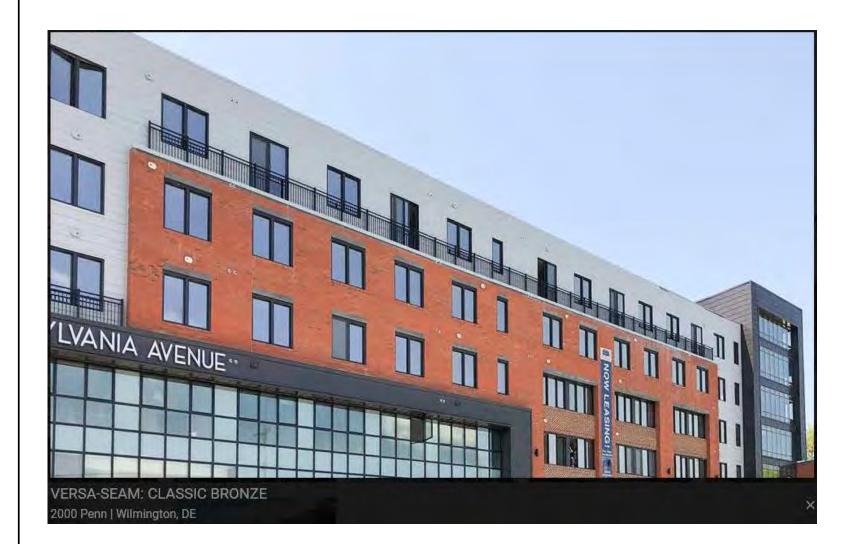

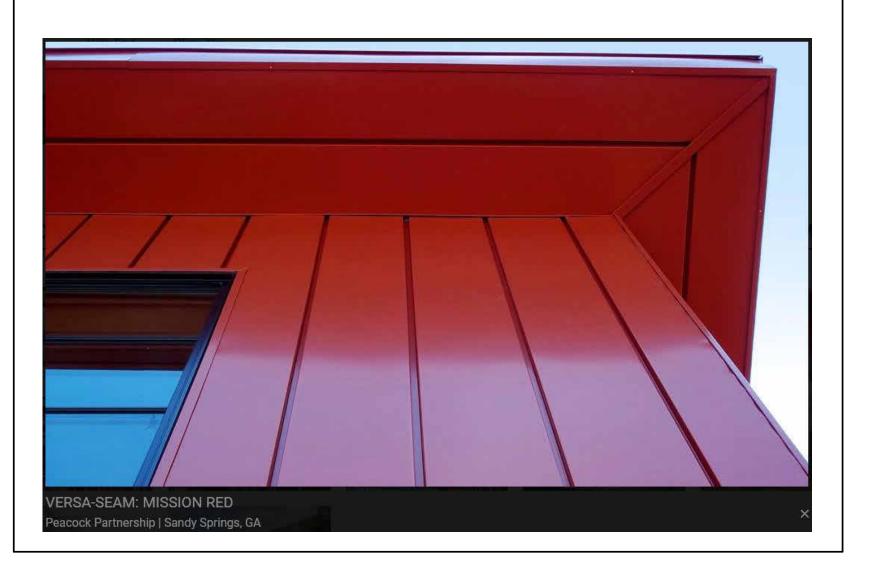

NATURAL METALS

Natural metals will weather and patina naturally over time, adding character and aesthetic appeal to any building design. In addition to natural metals, ATAS offers 55% Al-Zn alloy coated steel with acrylic coating and anodized aluminum as standard available materials.

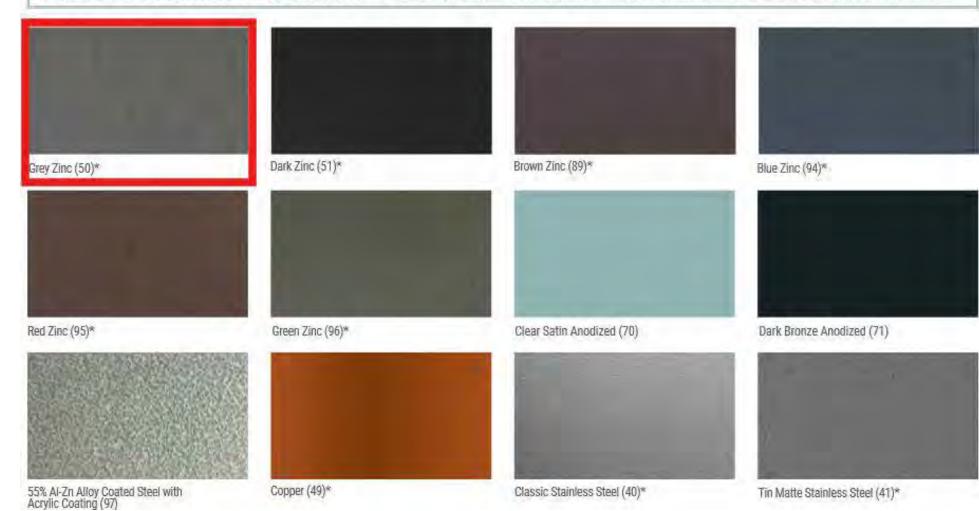

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ARCHITECT

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PROJECT: **Albany Street** Residences

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River Front Realty

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PROJECT TEAM:

DRAWING TITLE:

SIDING INFO



PERMITTING

DRAWING NUMBER: