


PROPOSED GARDEN LEVEL PLAN GROSS AREA - 1,480 SF-29.7 SF(FRONT UTILITY ROOM)-9 SF(BOILER ROOM)-10 SF (HVAC)-10 SF (LAUNDRY) = 1,421.3 SF

UNIT 1

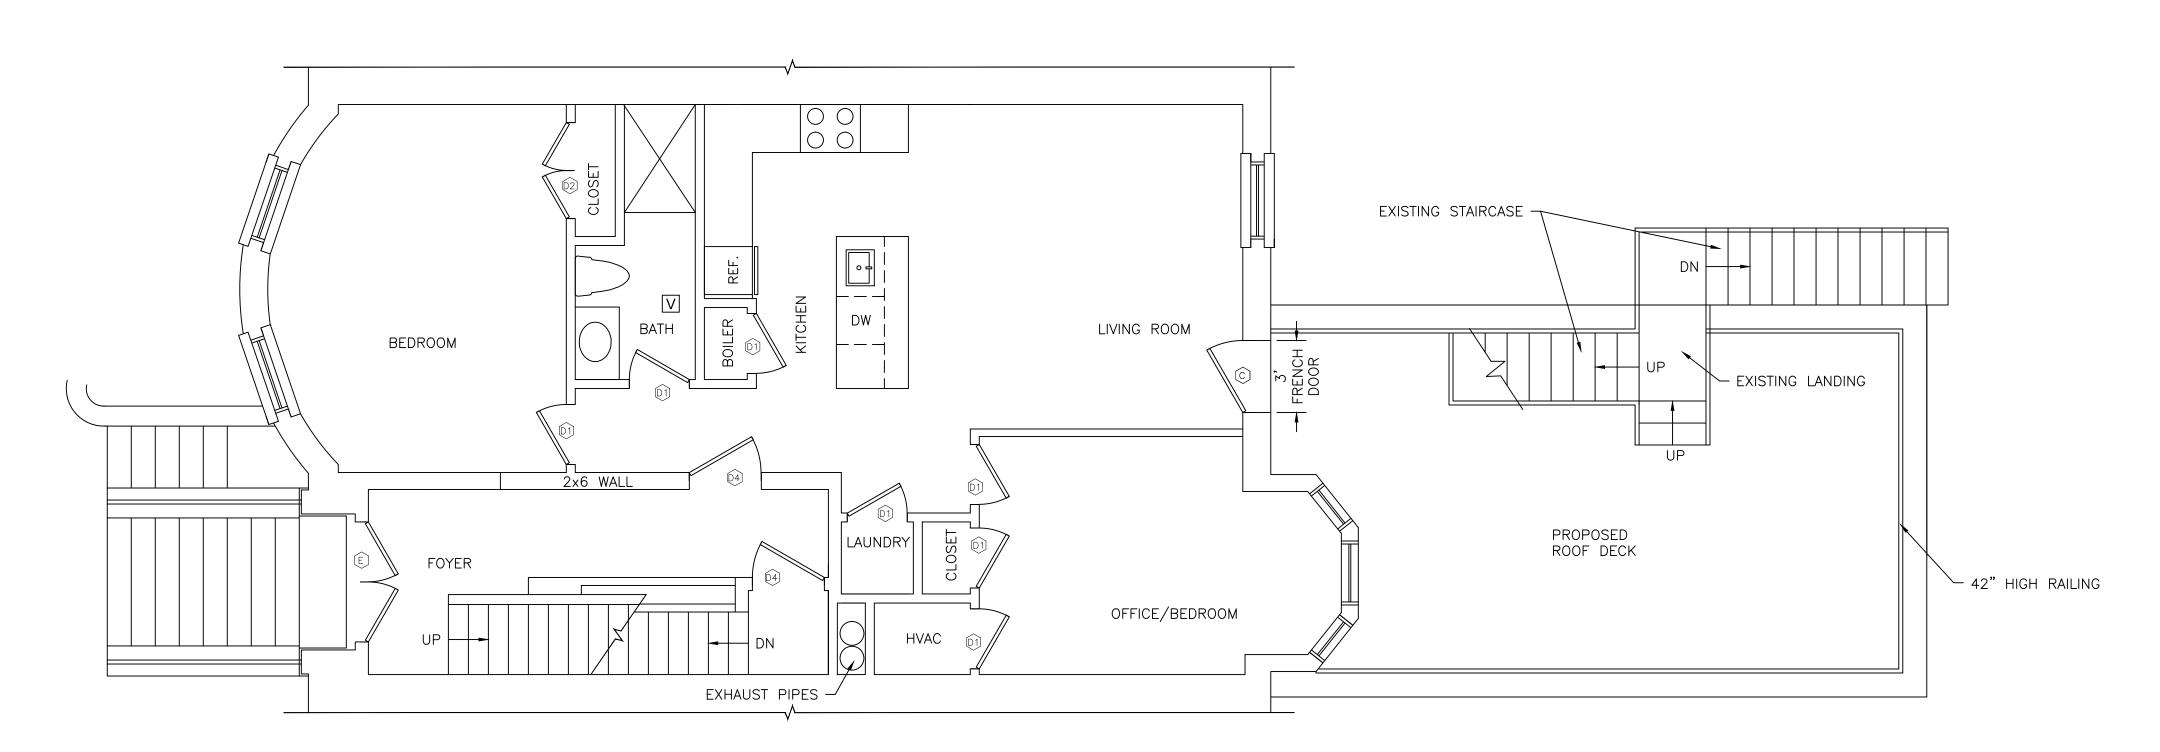

PROPOSED FIRST FLOOR PLAN GROSS AREA 1,059 SF-5.4 SF(BOILER)-9 SF(LAUNDRY)16.5 SF(HVAC WITH EXHAUSTS)=1,033.5 SF

UNIT 2

DOORS SCHEDULE:

(b) 2'-6" X 6'-8" (c) 4'-0" x 6'-8" DOUBLE DOOR (c) 2'-0" x 6'-8"

04) 3'-0" x 6'-8" FIRE RATED, 90 MIN C CUSTOM DOOR MEASURED IN FIELD E EXISTING DOOR

ALL DOORS MUST BE VERIFIED IN FIELD PRIOR TO DOOR ORDERING AND FRAMING

	DATE	REVISION
arrangements and plans shown on this docu not be used or reused in whole or in part, written consent of RAV&Assoc., Inc. Written over scaled dimensions. Contractors shall ve		is including, but not limited to, copyright and design patent rights, in the designs, and plans shown on this document are the property of RAV&Assoc., Inc. They may or reused in whole or in part, except in connection with this project, without the pricent of RAV&Assoc., Inc. Written dimensions on these drawings shall have precedence imensions. Contractors shall verify and be responsible for all dimensions and this project, and RAV&Assoc., Inc. must be notified of any variation from the and conditions shown by these drawings.


PROPOSED REAR EXTERIOR *MODIFICATIONS*


577 MASSACHUSETTS AVENUE BOSTON, MASSACHUSETTS

RAV & Assoc., Inc. 21 HIGHLAND AVENUE NEEDHAM, MASSACHUSETTS 02494 TELEPHONE: (781) 449-8200 FAX: (781) 449-8205

SCALE: 1/4"=1'-0"

DRAWING No. DATE: 9/21/2023

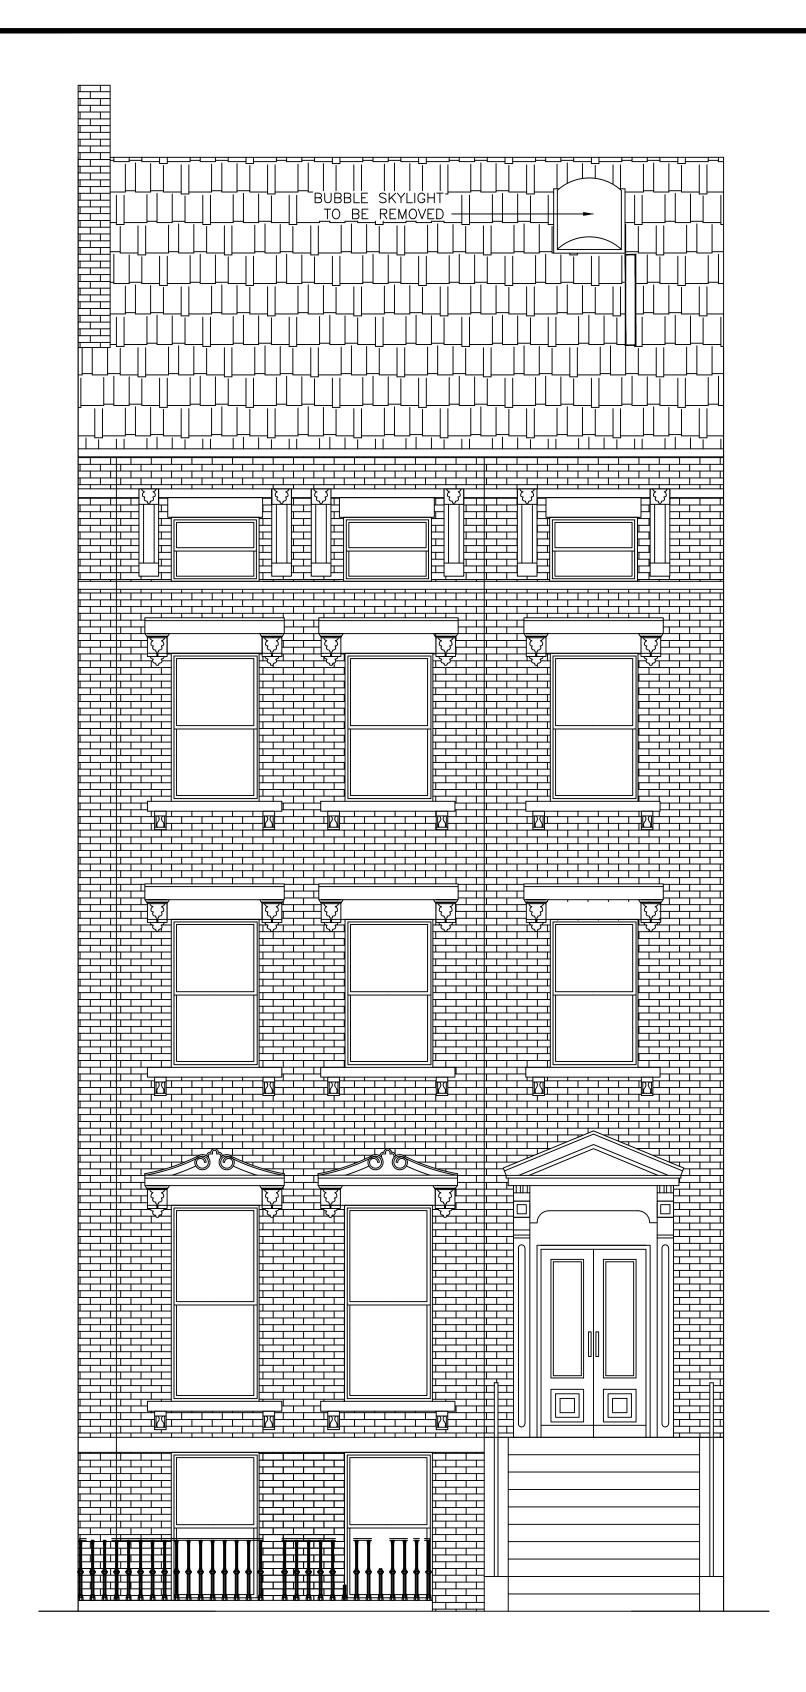

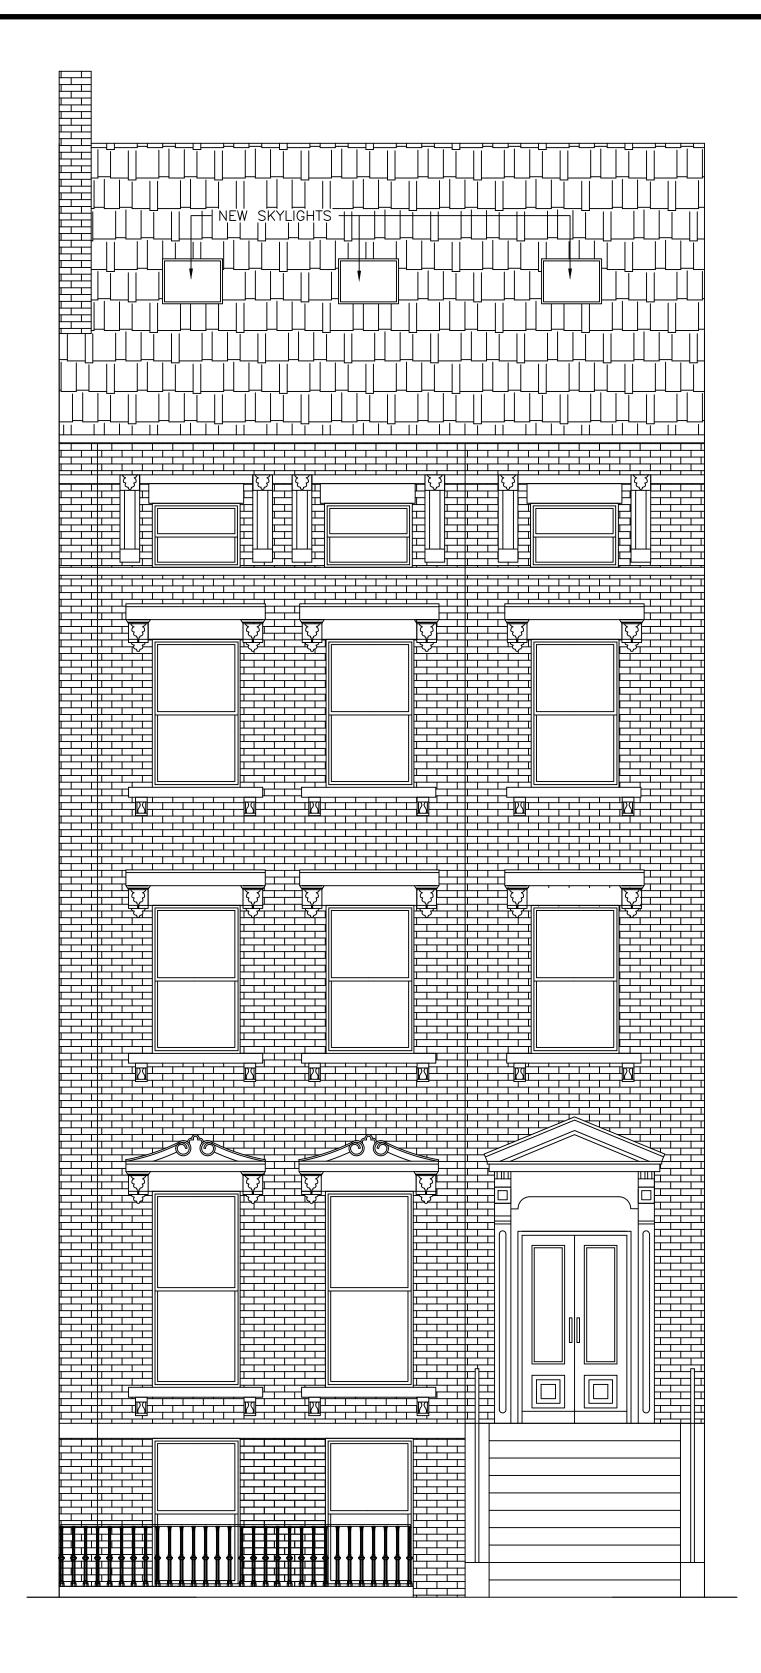

FRONT ELEVATION EXISTING CONDITION

FRONT ELEVATION PROPOSED CONDITION

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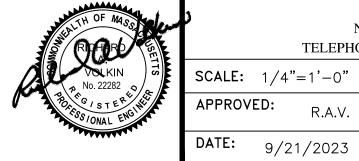
> EXISTING AND PROPOSED FRONT ELEVATION

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SCALE: 1/4"=1'-0"

DESIGNED BY: I.M. DRAWING No. DRAWN BY: I.M.





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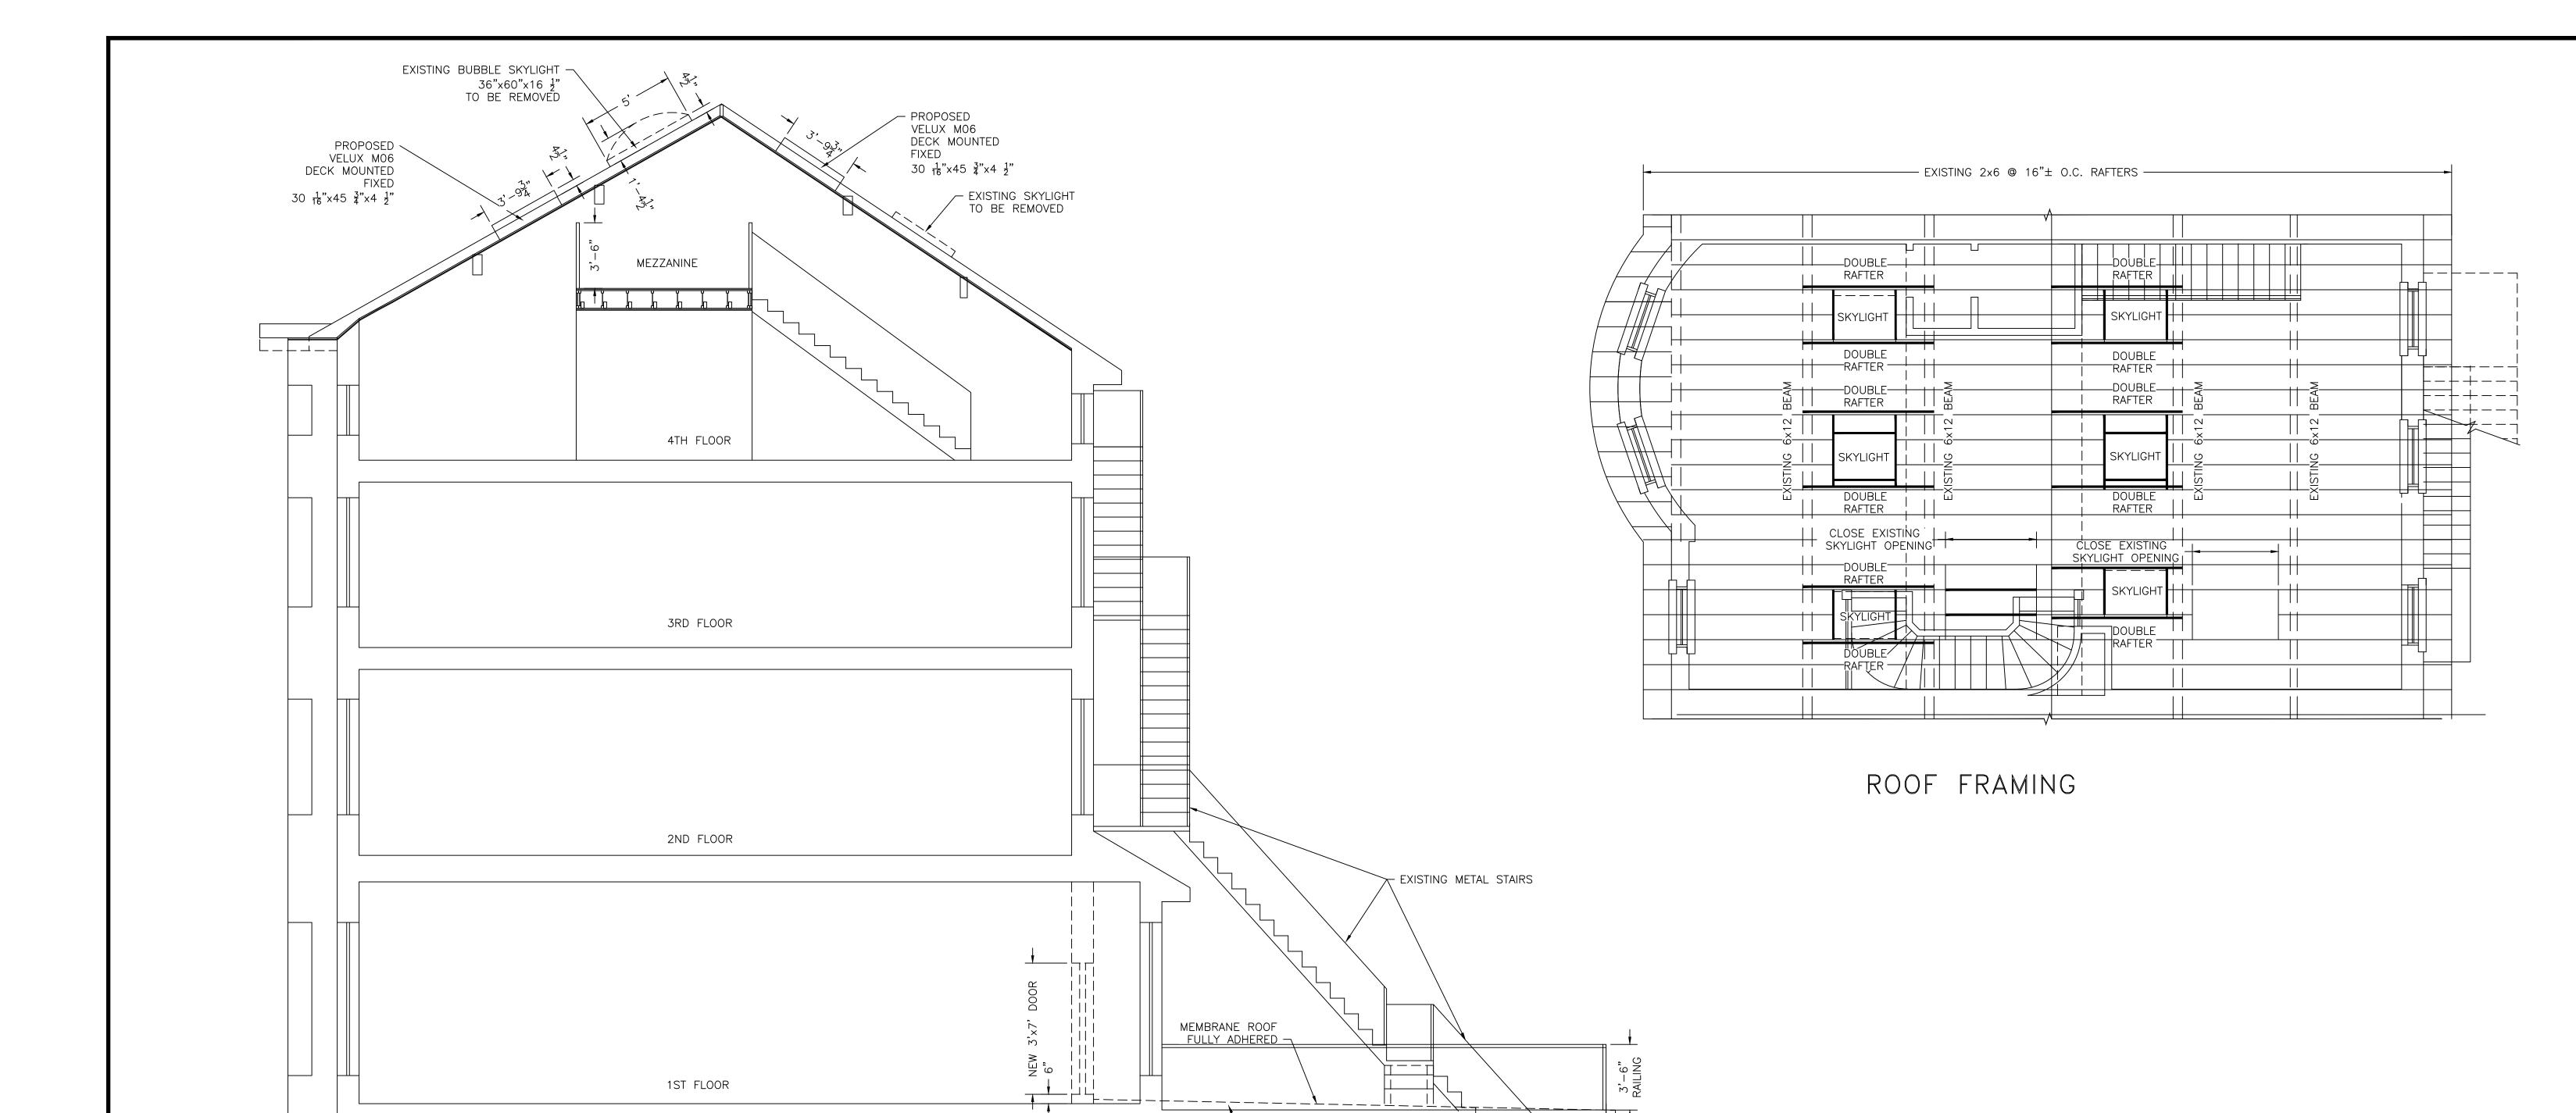
EXISTING AND PROPOSED REAR ELEVATION

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- TAPERED RIGID INSULATION

TO PROVIDE 1/4"/FT ROOF PITCH

PROPOSED CROSS SECTION THROUGH BUILDING

GARDEN LEVEL

NOTES:

FRONT (STREET) GRADE

AVERAGE GRADE

CARPENTRY:


- ALL ROUGH CARPENTRY SHALL PRODUCE JOINTS TRUE, TIGHT, WITH ALL MEMBERS ASSEMBLED IN ACCORDANCE WITH THE DRAWINGS AND WITH ALL PERTINENT CODES AND REGULATIONS. CAREFULLY SELECT ALL MEMBERS. SELECT INDIVIDUAL PIECES SO THAT KNOTS AND DEFECTS WILL NOT INTERFERE WITH PLACING BOLTS OR PROPER NAILING OR MAKING CONNECTIONS. LUMBER MAY BE REJECTED BY THE ENGINEER, WHETHER OR NOT IT HAS BEEN INSTALLED, FOR EXCESSIVE WARP, TWIST, BOW, CROOK, MILDEW, FUNGUS, OR MOLD, AS WELL AS FOR IMPROPER CUTTING AND FITTING.
- DO NOT SHIM SILLS, JOISTS, SHORT STUDS, TRIMMERS, HEADERS, LINTELS, OR OTHER FRAMING COMPONENTS. USE ONLY TREATED LUMBER FOR ALL WOOD BUCKS AND NAILING GROUNDS IN, OR IN CONTACT WITH CONCRETE.
- TREAT ALL WOOD LESS THAN TWO FEET ABOVE FINISHED GRADE BY SPRAYING WITH THE PRESERVATIVE TO A MINIMUM DISTANCE OF SIX INCHES FROM THE ENDS. PERFORM ALL TREATMENT IN STRICT ACCORDANCE WITH MANUFACTURER'S
- IN ADDITION TO ALL FRAMING OPERATIONS NORMAL TO FABRICATION AND ERECTION INDICATED ON THE DRAWINGS, INSTALL ALL BACKING REQUIRED FOR WORK OF OTHER TRADES. MAKE ALL BEARINGS FULL. FINISH ALL BEARING SURFACES ON WHICH STRUCTURAL MEMBERS ARE TO REST SO AS TO GIVE SURE AND EVEN SUPPORT. WHERE FRAMING MEMBERS SLOPE, CUT OR NOTCH THE ENDS AS REQUIRED TO GIVE UNIFORM
- INSTALL ALL BLOCKING REQUIRED TO SUPPORT ALL ITEMS OF FINISH AND TO CUT OFF ALL CONCEALED DRAFT OPENINGS, BOTH VERTICAL AND HORIZONTAL, BETWEEN CEILING AND FLOOR AREAS.
- FIRE BLOCKS SHALL BE TWO INCHES IN THICKNESS (NOMINAL) BY THE FULL WIDTH OF THE OPENING BEING BLOCKED. FIRE-BLOCK IN THE FOLLOWING SPECIFIC LOCATIONS:
- (1) IN ALL STUD WALLS AT CEILING AND FLOOR LEVELS;
- (2) IN ALL STUD WALLS, INCLUDING FURRED SPACES, SO THAT THE MAXIMUM DIMENSION OF EACH CONCEALED SPACE IS NOT MORE THAN EIGHT FEET;
- (3) ALL OTHER LOCATIONS WHERE OPENINGS COULD AFFORD PASSAGE FOR RODENTS OR FLAMES.
- INSTALL WOOD CROSS BRIDGING OF NOT LESS THAN TWO INCHES BY THREE INCHES NOMINAL, METAL CROSS BRIDGING OF EQUAL STRENGTH, OR SOLID BLOCKING BETWEEN JOISTS WHERE THE SPAN EXCEEDS EIGHT FEET. INSTALL SOLID BLOCKING BETWEEN JOISTS AT ALL POINTS OF SUPPORT AND WHEREVER SHEATHING OR FLOORING IS DISCONTINUOUS.
- MAKE ALL STUDS SINGLE LENGTH, UNSPLICED, AND PLATFORM FRAMED. FRAME ALL CORNERS AND INTERSECTIONS WITH THREE OR MORE STUDS AND ALL REQUIRED BEARING FOR WALL FINISH. ON ALL FRAMING MEMBERS TO RECEIVE A FINISHED WALL OR CEILING, ALIGN THE FINISH SUBSURFACE TO VARY NOT MORE THAN 1/8" FROM THE PLANE OF SURFACES OF ADJACENT FRAMING AND FURRING MEMBERS.
- PLACE ALL PLYWOOD WITH FACE GRAIN PERPENDICULAR TO SUPPORTS AND CONTINUOUSLY OVER AT LEAST TWO SUPPORTS. ALL DOORS AND WINDOWS MUST BE INSTALLED WITH ALL NECESSARY APPURTENANCES AND TRIMS.

NOTES:

AVERAGE GRADE

REAR GRADE

- ALL EXPOSED WOOD AND WOOD IN DIRECT CONTACT WITH CONCRETE MUST BE PRESSURE TREATED.
- THE PROPERTIES OF WOOD MUST BE AS DESIGNED OR BETTER.
- SIMPSON CONNECTORS MUST BE USED AND INSTALLED IN ACCORDANCE WITH THE MANUFACTURER'S SPECIFICATIONS.
- CONTRACTOR MUST VERIFY ALL DIMENSIONS IN FIELD. IF ADJUSTMENTS ARE NECESSARY, CONTACT THE ENGINEER.

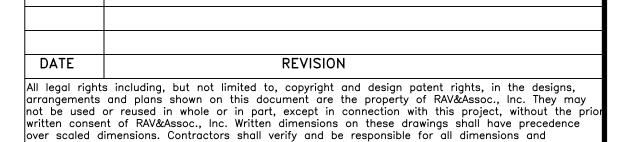

PROPOSED ROOF FRAMING AND CROSS SECTION WITH EXTERIOR MODIFICATIONS 577 MASSACHUSETTS AVENUE

conditions on this project, and RAV&Assoc., Inc. must be notified of any variation from the

dimensions and conditions shown by these drawings.

BOSTON, MASSACHUSETTS **RAV** & Assoc., Inc.

21 HIGHLAND AVENUE NEEDHAM, MASSACHUSETTS 02494 TELEPHONE: (781) 449-8200 FAX: (781) 449-8205

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